O507 INDUSTRIES LTD.
PROPOSED NEW FACILTY
8 EASY STREET
PORT PERRY, ONTARIO

Architectural Drawing Set

DRAWING INDEX


| DWG No. | DRAWING TITLE |
|------------|----------------------------|
| A1.0 | GENERAL LAYOUT & OBC NOTES |
| A1.1 | SCHEDULES & NOTES |
| A2 | MAIN LEVEL FLOOR PLAN |
| A3 | SECOND LEVEL FLOOR PLAN |
| A4 | ROOF PLAN |
| A5 | REFLECTED CEILING PLAN |
| A6 | INTERIOR FINISHES |
| AX1 | ELEVATION VIEWS |
| AX2 | SECTION VIEWS |
| AD1 | SECTION DETAILS |


0507 INDUSTRIES LTD.
Architectural Drawing Set

PROJECT #: 21016


DRAWING SET: R5 - ISSUED FOR PERMIT




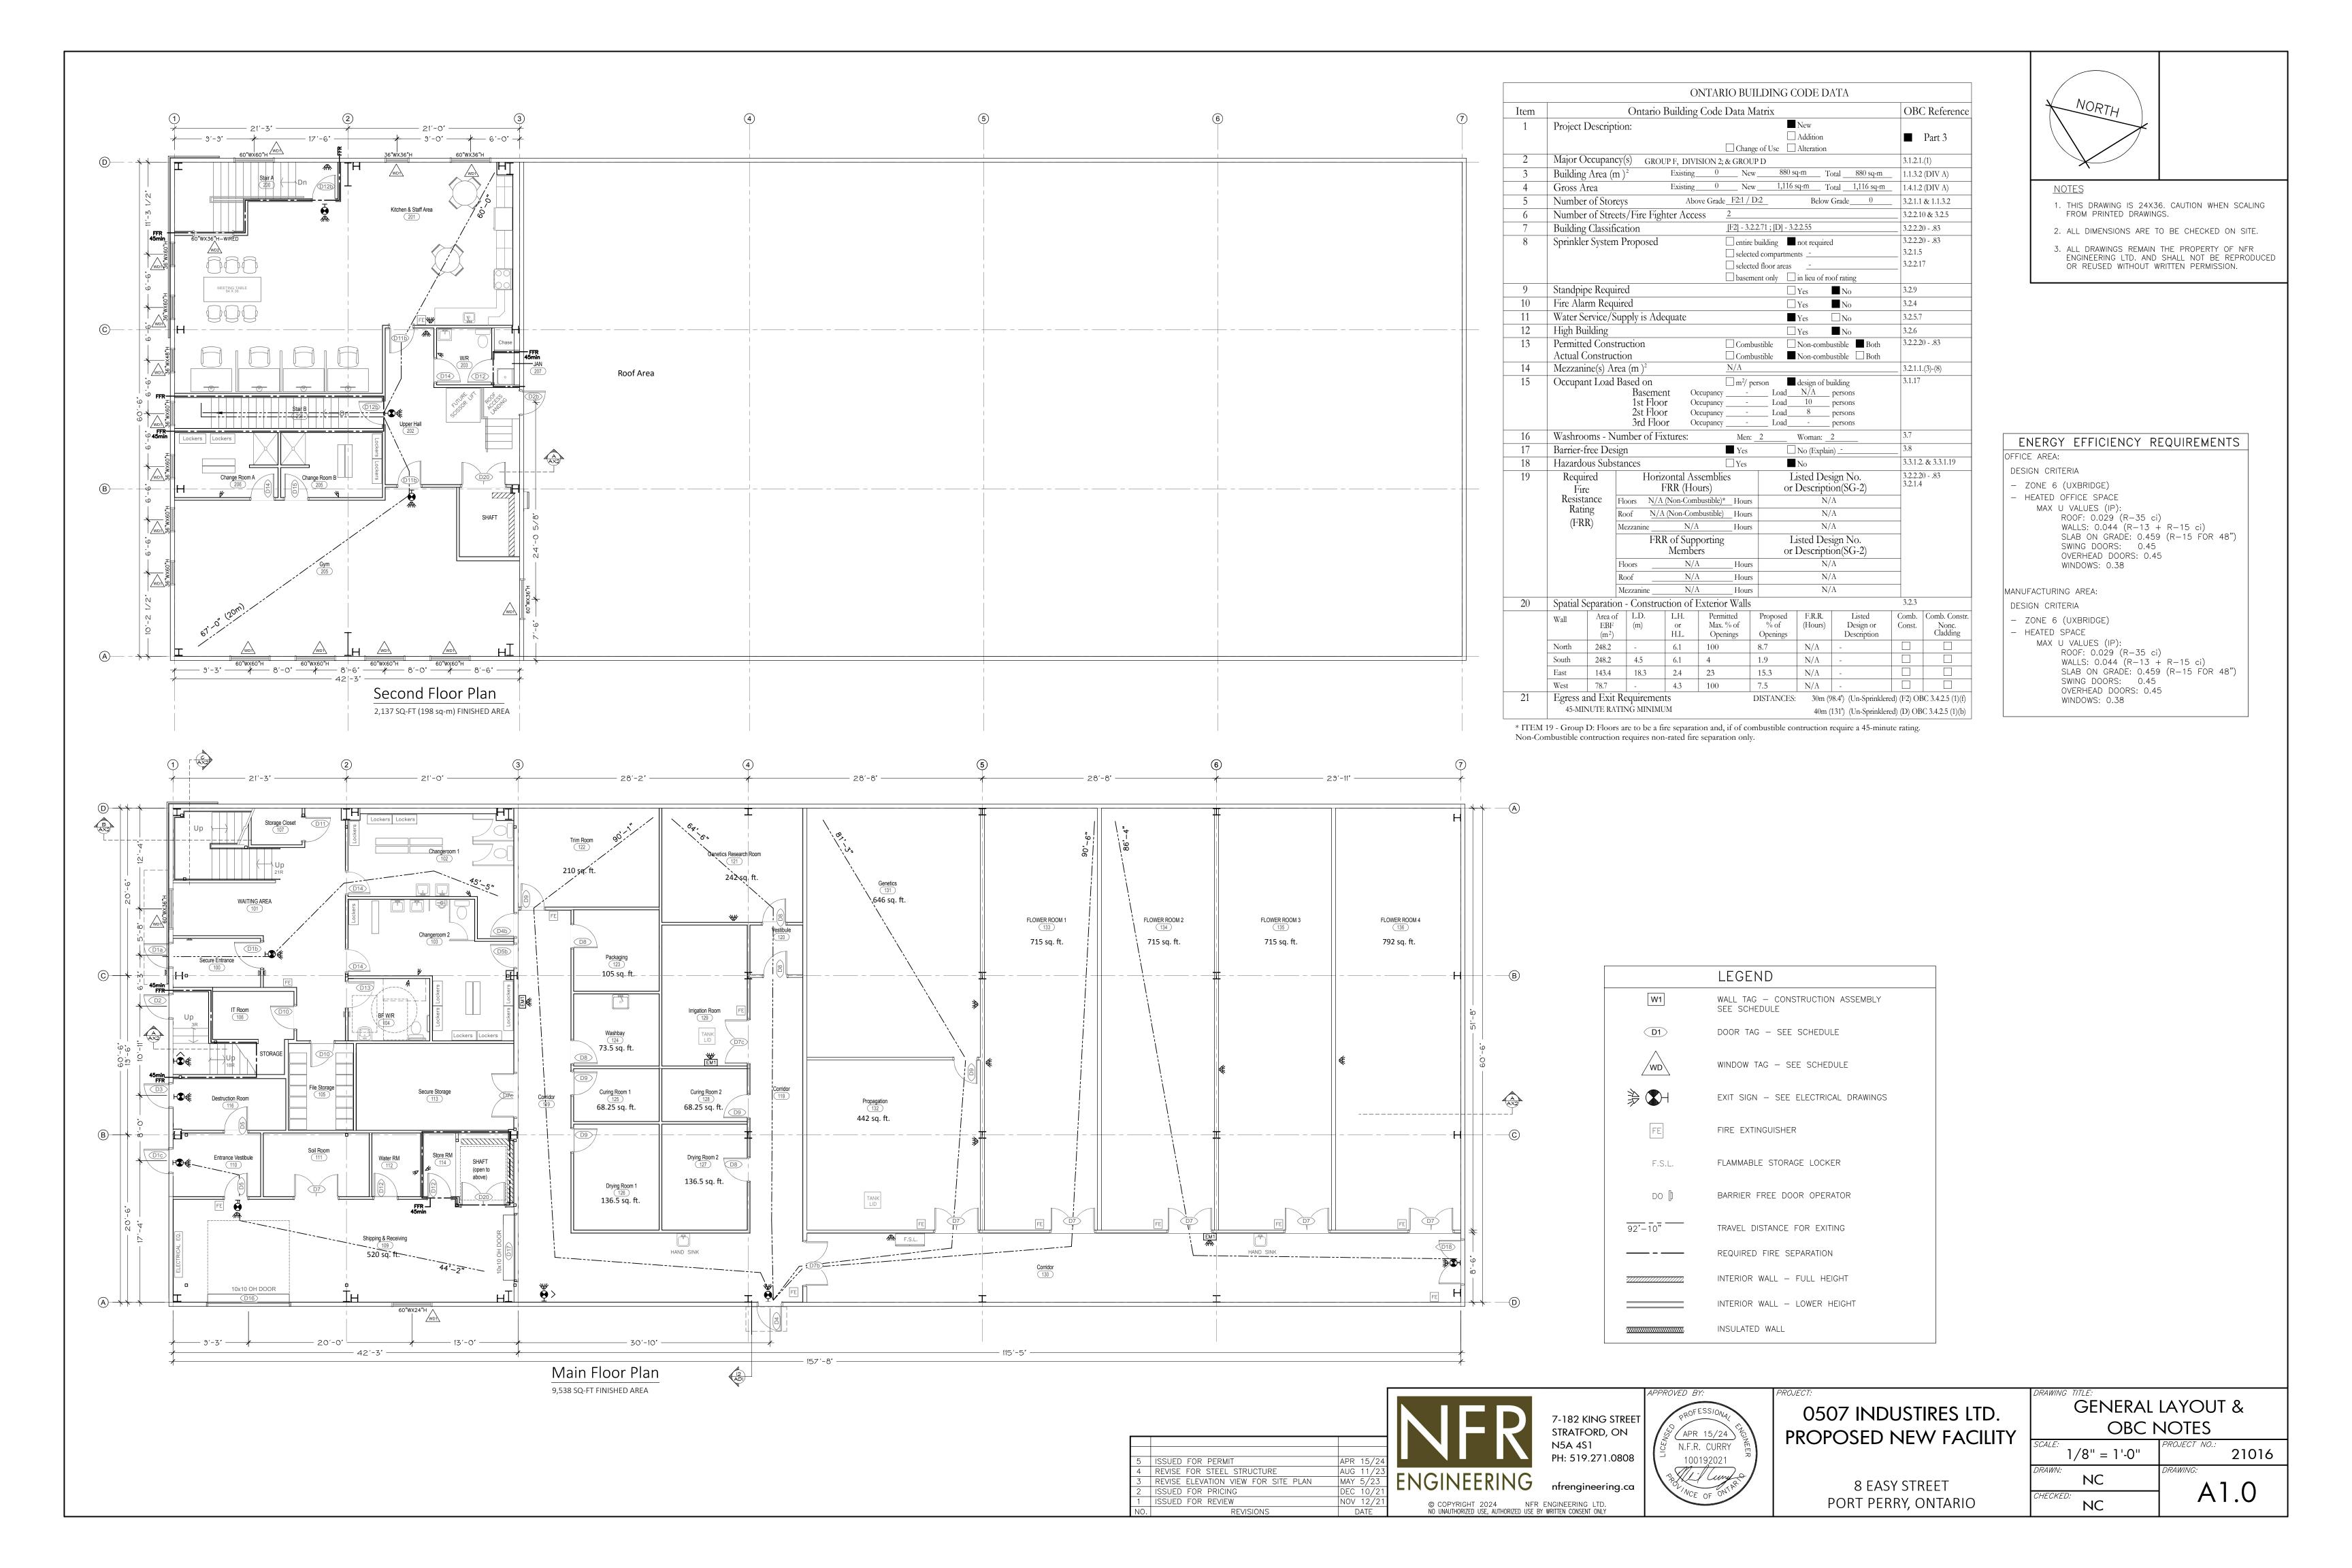


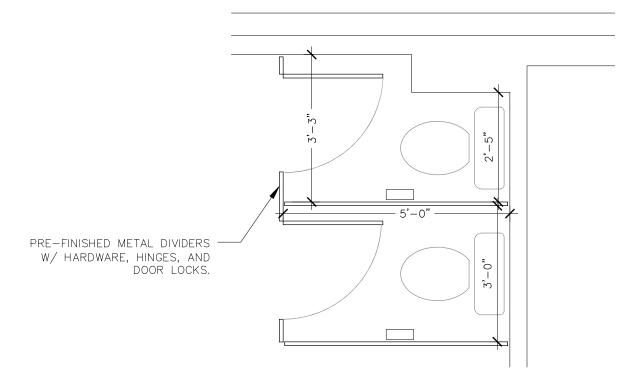



WOMANS WASHROOM LAYOUT

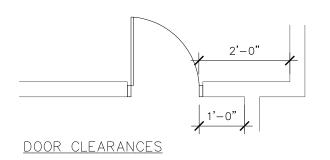

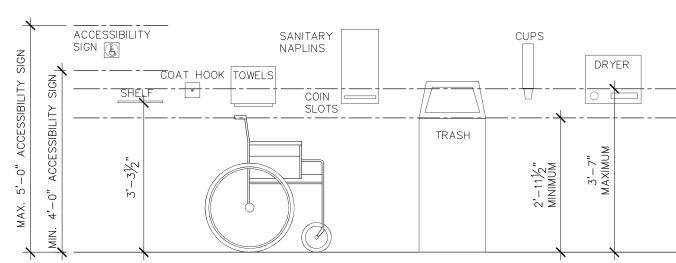


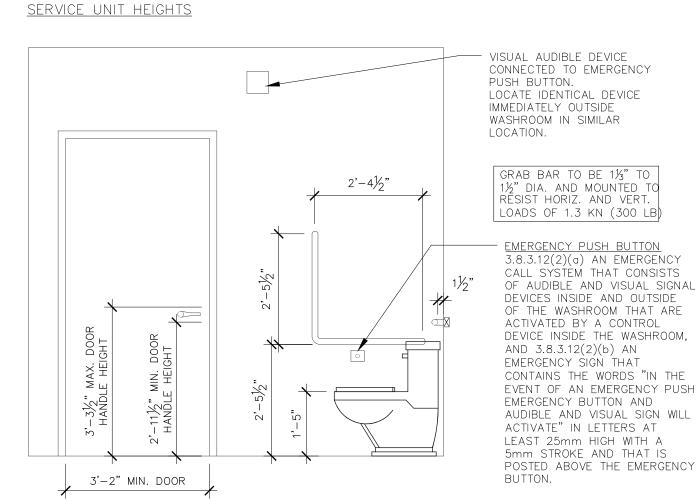


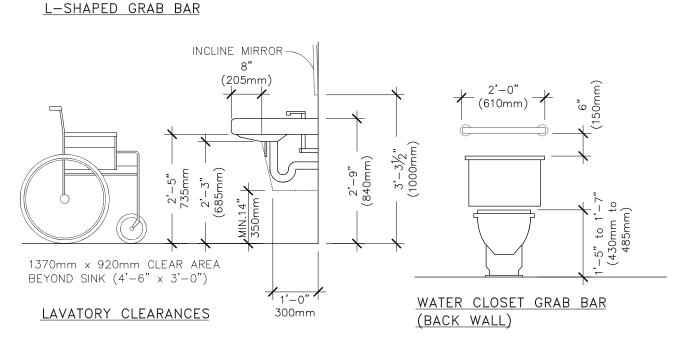

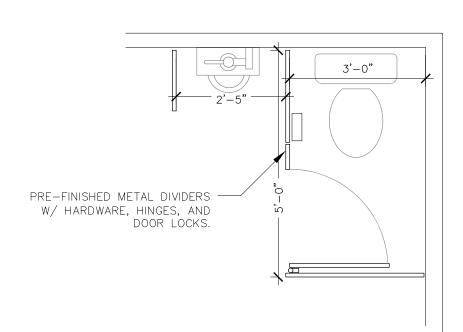

MENS WASHROOM LAYOUT

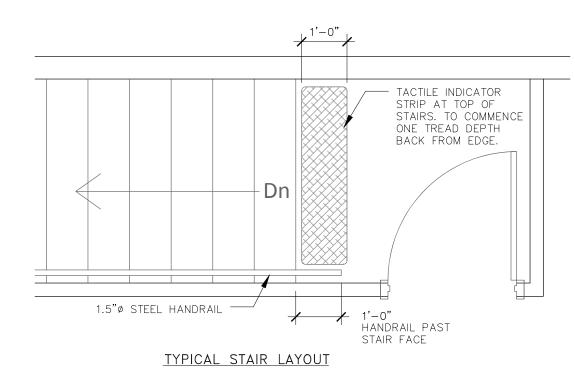

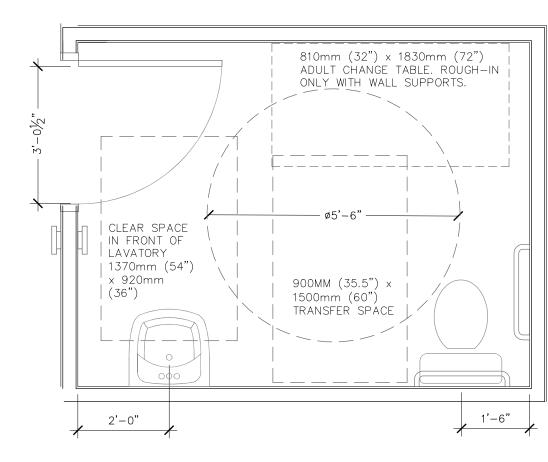

UNIVERSAL WASHROOM LAYOUT

GENERAL NOTES & SPECIFICATIONS

- 1. ALL DIMENSIONS SHALL BE VERIFIED AT THE SITE. ALL INTERIOR DIMENSIONS LISTED ARE FROM FACE OF STUDS AND NOT THE WALL
- FINISHED SURFACE. 2. READ ALL OF THE PROJECT DRAWINGS AND SPECIFICATIONS (ARCHITECTURAL, STRUCTURAL, MECHANICAL, ELECTRICAL, ETC.) BEFORE CONSTRUCTION.
- 3. IT IS THE RESPONSIBILITY OF THE CLIENT AND BUILDER TO NOTIFY THE ENGINEER OF ANY CHANGES IN SCOPE OF WORK, WORK PERFORMED BY OTHER PARTIES THAT AFFECTS THE WORK, OR ANY DISCREPANCIES
- 4. INFORM THE ENGINEER A MINIMUN OF 48 HOURS PRIOR TO ANY REQUIRED INSPECTIONS. (E.G. SOIL VERIFICATION, REBAR, STRUCTURAL STEEL & CONNECTIONS, ETC).

SHOP DRAWINGS TO BE SUBMITTED AS REQUIRED FOR THE FOLLOWING:

- 1. STRUCTURAL STEEL DRAWINGS.
- STRUCTURAL FOUNDATION DRAWINGS. STRUCTURAL MEZZANIZE DRAWINGS.
- 4. WALL PANELS & CANOPY STRUCTURES.
- 5. DOORS AND DOOR HARDWARE. 6. WINDOWS.

FOUND DURING THE WORK.

7. WASHROOM ACCESSORIES.

GENERAL CONSTRUCTION NOTES

- 1. ALL WORK TO BE ACCORDING TO THE ONTARIO BUILDING CODE AND BY SKILLED TRADES EXPERIENCED IN THE TYPE OF WORK INVOLVED.
- 2. ALL CONNECTIONS AND NAILING AS PER O.B.C., JOIST HANGERS AND BEAM SADDLES OR OTHER CONNECTIONS TO BE SUITABLY RATED FOR THE
- MATERIALS AND POSITION RELATED TO THE INSTALLATION. 3. ALL STUD WORK TO BE SPACED AT 16" O/C UNLESS SPECIFIED. 4. WALL STUD SPECIFIED AS 3-1/2" MAY BE INCREASED TO 5-1/2" TO ALLOW
- FOR PLUMBING AND OTHER SERVICES. 5. PROVIDE SOLID BLOCKING AT MID HEIGHT FOR ALL STUD WALLS EXCEEDING
- 6. PROVIDE BACKING SUPPORT AND ANCHORAGE FOR ALL INTERIOR WALLS AND
- FOR THE ATTACHMENT OF EQUIPMENT AND ACCESSORIES AS REQUIRED. 7. ALL FIRE-RATED WALLS AND ASSEMBLIES TO HAVE ALL OPENINGS AND PENETRATIONS FIRE STOPPED AND SEALED AS REQUIRED BY THE O.B.C. AND WITH APPROPRIATELY APPROVED SEALANTS AND FIRE STOP MATERIALS OR

- 1. THIS DRAWING IS 24X36. CAUTION WHEN SCALING FROM PRINTED DRAWINGS.
- 2. ALL DIMENSIONS ARE TO BE CHECKED ON SITE.
- 3. ALL DRAWINGS REMAIN THE PROPERTY OF NFR ENGINEERING LTD. AND SHALL NOT BE REPRODUCED OR REUSED WITHOUT WRITTEN PERMISSION.

WALL SCHEDULE

- W1 EXTERIOR INSULATED WALL
- INSULATED METAL PANELS 6" METAL CLAD FOAM PANELS R32 (BY OTHERS) METAL GIRTS AS PER STEÈL BUILDING
- SUPPLIER (PRE-ENGINEERED STEEL BUILDING)
- INTERIOR EXPOSED STEEL PANEL SKIN
- W1a ADD TO W1:
- 1/2" PLYWOOD OR OSB SCREWED TO INSULATED METAL PANELS
- WATER MEMBRANE, MORTAR, LATH AND STONE BRICK VENEER AS PER MFR'S INSTRUCTIONS
- W1b ADD TO W1:
- 1X2 VERTICAL STRAPPING SCREWED TO INSULATED METAL PANELS
- HORIZONTAL WOOD SIDING AS PER MFR'S INSTRUCTIONS
- w2* INTERIOR (SHORT)
- 1/2" GYPSUM WALL BOARD 3-5/8" METAL STUDS
- 1/2" GYPSUM WALL BOARD W3* • INTERIOR (TO UNDERSIDE DECK/FLOOR)
- 1/2" GYPSUM WALL BOARD • 3-5/8" METAL STUDS
- 1/2" GYPSUM WALL BOARD
- w4 INTERIOR (TO UNDERSIDE DECK/FLOOR) INSULATED METAL PANEL BY OTHERS 4" THICK, R19
- W4a INTERIOR (SHORT)

SIZE

D1a

D1b

D1c

D2

D2b

D4

D4b

D10

D11

D12b

D13

D14

D15

D16

D17

D20

ISSUED FOR PERMIT
REVISE FOR STEEL STRUCTURE

ISSUED FOR PRICING
ISSUED FOR REVIEW

REVISE ELEVATION VIEW FOR SITE PLAN

ABREVIATIONS:

DC - DOOR CLOSER

3'-2" X 7'-0"

(2) 4'-0" X 8'-0"

3'-2" X 7'-0"

10' X 10'

10' X 10'

(2) 4'-0" X 8'-0"

FR - FIRE RATED (54 MIN.) AS REQUIRED

ALUM. TRAFFIC — ALUMINUM CLAD INDUSTRIAL

D18 (2) 4'-0" X 8'-0"

H.M. — HOLLOW METAL DOOR

D7b | (2) 4'-0" X 8'-0"

D7c | (2) 4'-0" X 8'-0"

- INSULATED METAL PANEL BY OTHERS 4" THICK, R19
- *add: SOUND BATT INSULATION IN STUD SPACE WHERE SHOWN ON PLANS

DOOR SCHEDULE

TYPE

FINISH

PAINTED H.M.

D POLY TRAFFIC PULL, DC

D POLLY TRAFFIC PULL, DC

PAINTED WOOD | PAS

PAINTED WOOD | PAS

PAINTED WOOD | PAS

PAINTED H.M. FR, DC, T

PAINTED H.M. FR, DC, T

EΧ

FR, DC, T

PULL- PUSH/PULL

PDO (RAPID SYSTEM)

PAN - PANIC RELEASE HARDWARE

SWG - SWING DOOR, 2-WAY HINGES

KICK - LOWER KICK PLATE PROTECTION

PAINTED WOOD PDO, PAS

PAINTED H.M. | EX, PAN

PAINTED WOOD PAS

A PAINTED WOOD PAS

PAINTED H.M.

TRAFFIC STYLE DOORWAY SYSTEM T - THUMB LATCH

EX - EXTERIOR INSULATED & WEATHER STRIPPING PAS - PASSAGE SET (KEYED) EL - ELECTRONIC LATCH FOR SECURITY PURPOSES PDO - POWER DOOR OPERATOR

OVERHEAD

RAPID

PAINTED H.M.

ALUM. TRAFFIC | SWG, KICK

ALUM. TRAFFIC | SWG, KICK

PAINTED H.M.

WALL SCHEDULE

- w5 INTERIOR (TO UNDERSIDE DECK/FLOOR) • 1/2" GYPSUM WALL BOARD
- 6" METAL STUDS C/W ROCKWOOL BATTS • 1/2" PVC TRUSSCÓRE WALL BOARD — GREY
- W6 INTERIOR WALL (IN-FILL)
- 1/2" DRYWALL BOARD
- VÉRTICAL STRAPPING 16" 0/C 8" HORIZONTAL STEEL GIRTS
- W7 RATED INTERIOR (TO UNDERSIDE
- DECK/FLOOR) • 5/8" TYPE-X GYPSUM WALL BOARD
- 5-1/2" (550S) METAL STUDS 16" O/C AND ROCKWOOL BATTS
- GYPSUM WALL BOARD TO MATCH BACKSIDE ROOM
- W8 SHAFT/HOISTWAY WALLS (FUTURE WALL ONLY, NOT IN PROJECT)
- 8" CONCRETE BLOCK WITH REINFORCMENT AND FILLED BLOCKS AT RAIL BRACKET
- LOCATIONS. FINAL DESIGN BY OTHERS AND AS PER EQUIPMENT SUBMITTALS

WINDOW SCHEDULE

WD1 SEALED DOUBLE GLAZED ALUMINUM WINDOW AND LOW-E SURFACE COATING; MAX U-VALUE OF 0.38 (BTU/hr/sq-ft°F)

WD2 SEALED SINGLE GLAZE RATED WINDOW W/ WIRE. RATED FRAME AND MOUNTING.

|COUNT | LOCATION

FRONT

VESTIBULE

FRONT

FRONT

ROOF

FRONT

SIDE

102 exit

110, 116

103 exit

6 | 111, 132, FLOWER(x4)

COR 130

113, 129

120, 121, 123, 124,

122, 125, 126, 128,

105, 106, 206

107

201, 205

112, 114, 207

200, 204

BF WR 104

102, 103, 206, 203

205

SHIPPING

SHIPPING

REAR

SHAFT ENTRY & EXIT

HARDWARE

EX, PAS, T

PULL, DC

PULL, DC

PULL, DC

SWG, PAS

EX, PAN, DC

EX, PAS, PAN, PDO

EX, PAS, PAN, PDO

EX, PAS, PAN, DC

EX, PAS, PAN, DC

EX, EL, PAS, PAN

ROOF & FLOOR SCHEDULE


- R1 14-FOOT PRODUCTION AREA INSULATED METAL PANELS BY STEEL
- BUILDING SUPPLIER. 6" (R35) VAPOUR BARRIER AND SEALANT AS PER
- DETAILS. PRE-FAB STEEL BUILDING AS PER SUPPLIER (PRE-ENGINEERED BLDG) - 8" PURLINS ON STEEL SUPPORT STRUCTURE.
- R2 OFFICE AREA
- INSULATED METAL PANELS BY STEEL BUILDING SUPPLIER. 6" (R35)
- VAPOUR BARRIER AND MEMBRANE SEALANT AS PER DETAILS.
- PRE-FAB STEEL BUILDING AS PER SUPPLIER (PRE-ENGINEERED BLDG) - 8" PURLINS ON SUPPORT STRUCTURE.
- F1 FLOOR SLAB ON GRADE 4" CONCRETE SLAB
- VAPOUR RETARDER • 3" PERIMETER INSULATION (R15) EXTENDED
- 48" HORIZONTALLY FROM INSIDE FACE OF FOUNDATION WALL
- COMPACTED GRANULAR FILL PROVIDE SAWCUT CONTROL JOINTS C/W
- F2 COMPOSITE CONCRETE FLOOR
- (TO BE AS PER STEEL DRAWINGS BY OTHERS) 4" CONCRETE SLAB W/ W.W.M.
- RIBBED STEEL PAN OWSJ STRUCTURE AS PER STEEL DRAWINGS


HOLLOW METAL DOORS & FRAMES

STEEL DOORS TO BE 16ga GALVINIZED STEEL ASTM A527

EXTERIOR DOORS TO BE INSULATED AND TO HAVE A THERMALLY BROKEN FRAME WITH WELDED CONSTUCTION, DOOR SWEEPS AND SEALS. SEE DRAWING AX1 FOR COLOUR.

RATED DOORS TO HAVE FULLY RATED DOOR AND FRAME ASSEMBLY WITH UNPAINTED LABELS IDENTIFYING DESIGNED FIRE RATING AND TO INCLUDE SELF-CLOSING DEVICES AND SELF LATCH HARDWARE.

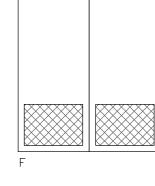

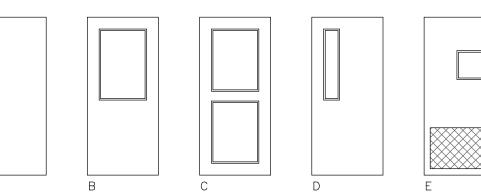

DOOR TYPES




NO UNAUTHORIZED USE, AUTHORIZED USE BY WRITTEN CONSENT ONLY


0507 INDUSTIRES LTD. PROPOSED NEW FACILITY APR 15/24 N.F.R. CURRY


> 8 EASY STREET PORT PERRY, ONTARIO

SCHEDULES & NOTES

N.T.S. 21016 NC AI. NC

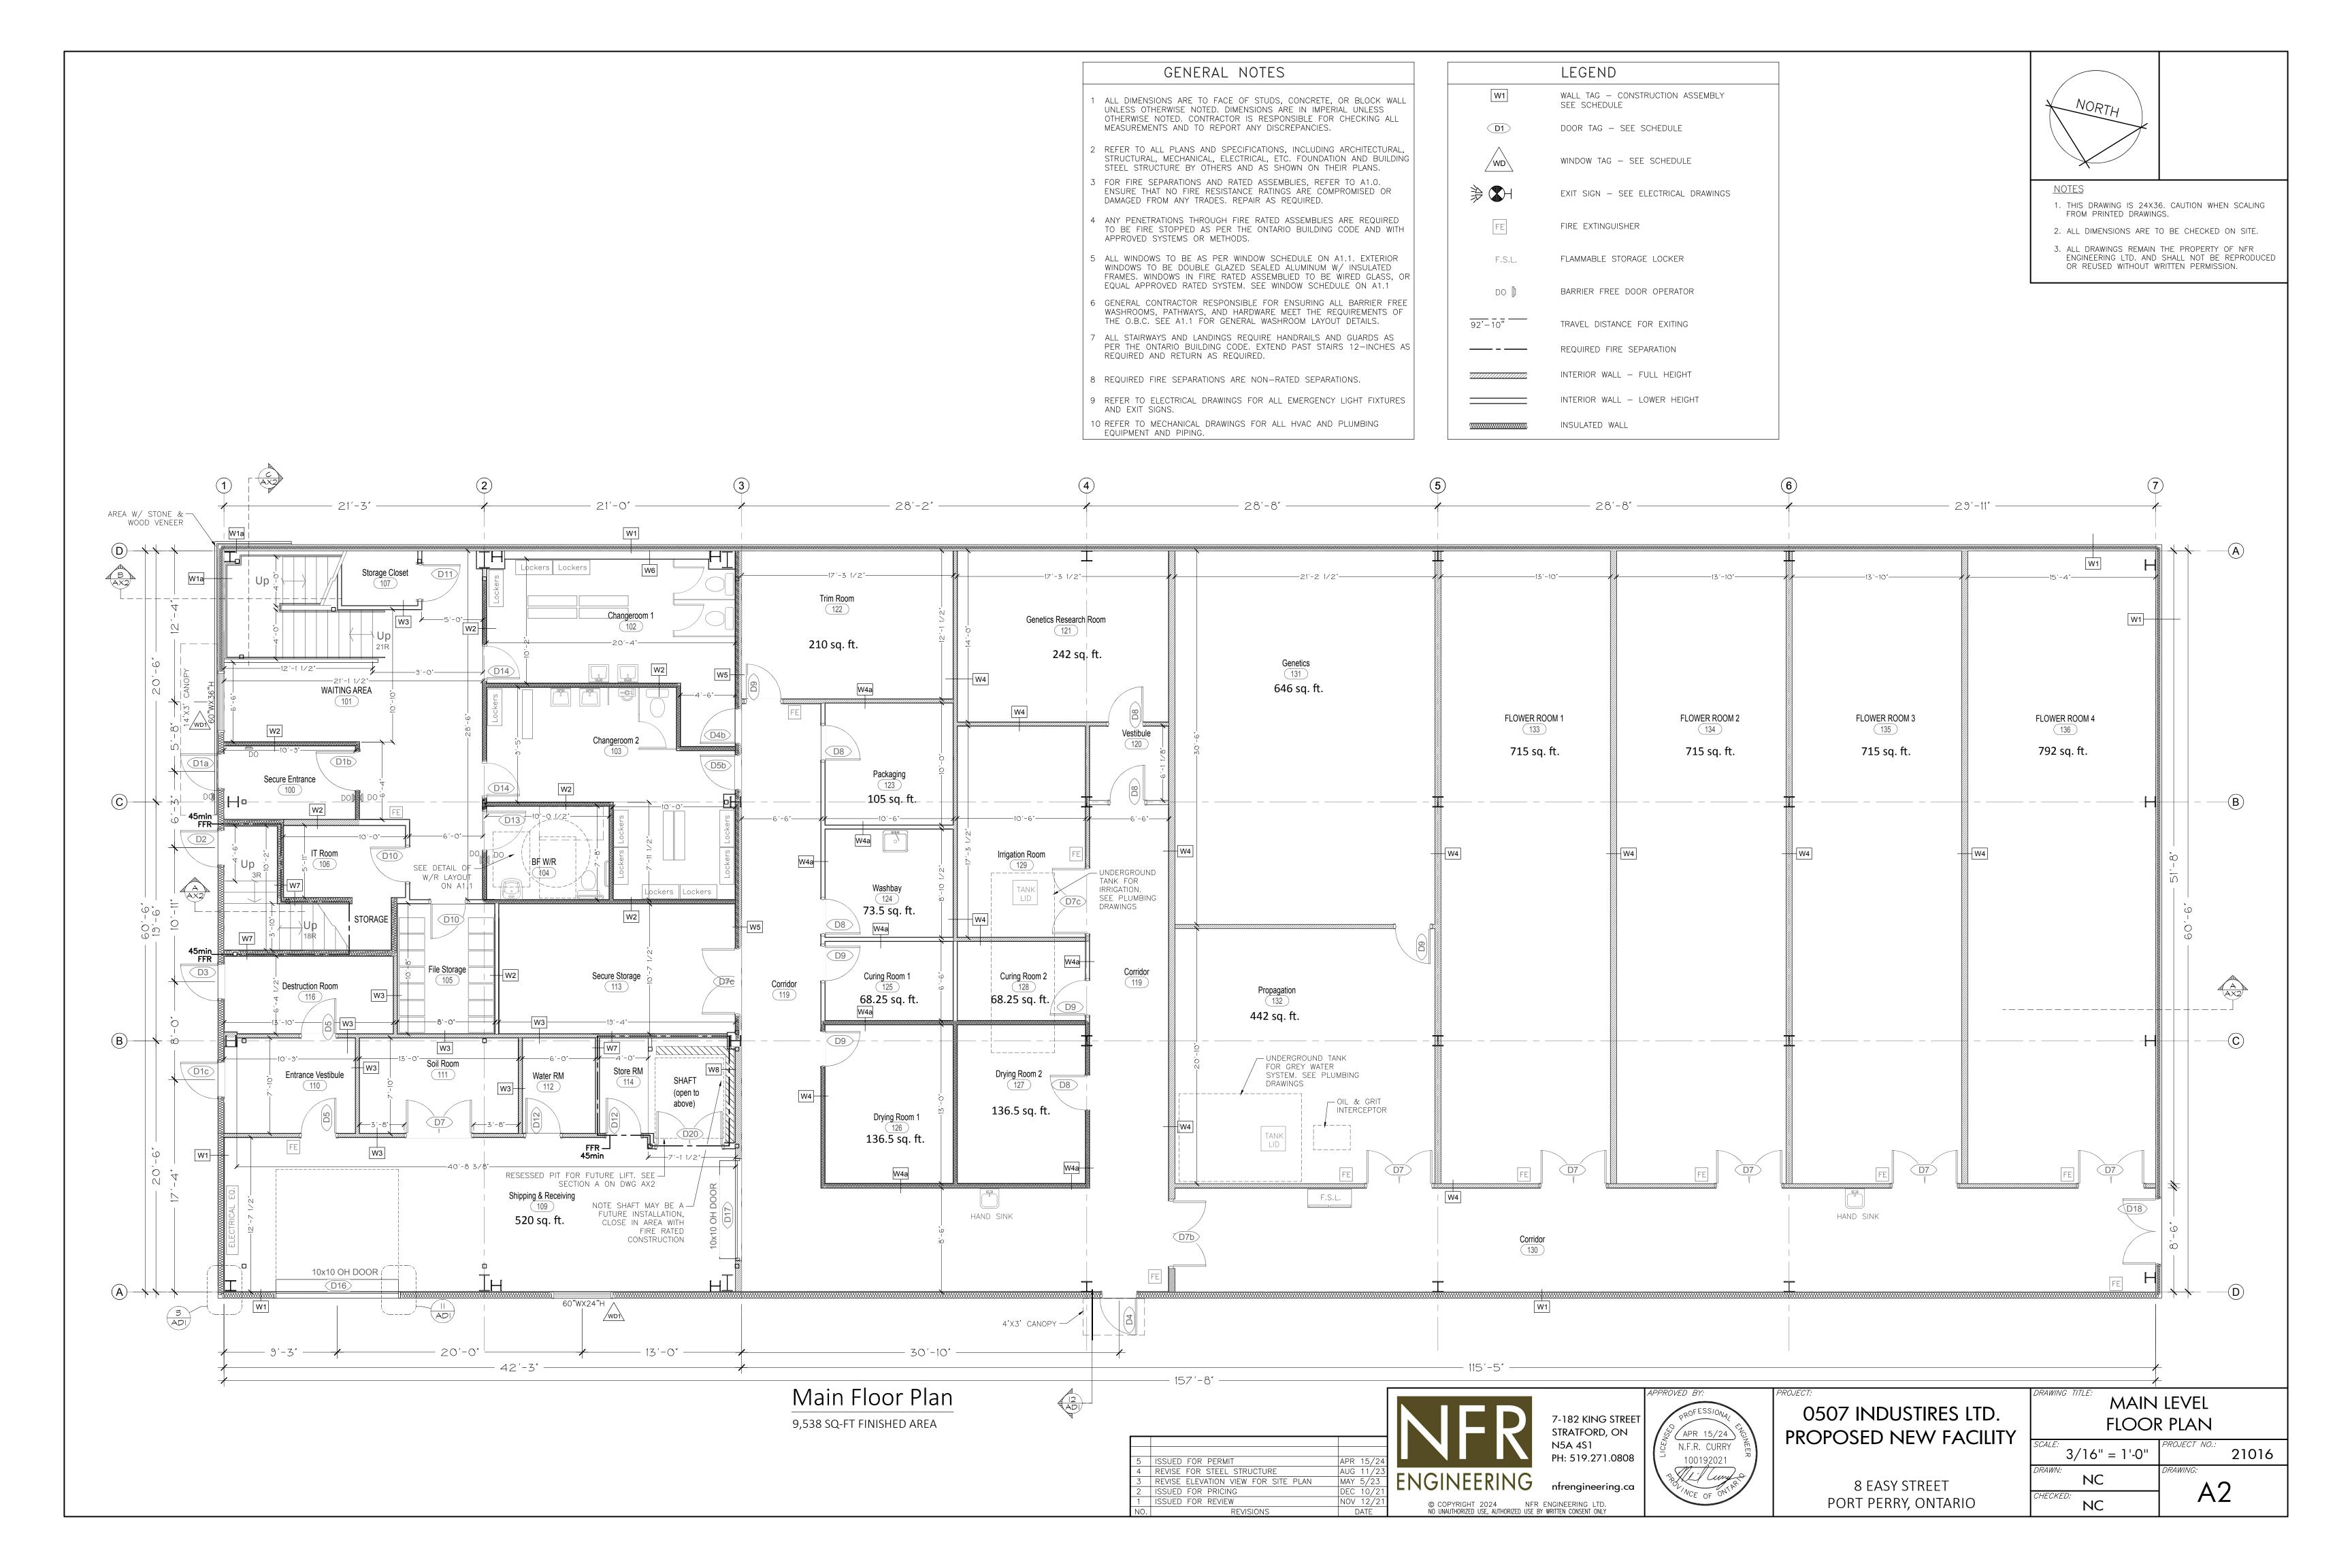

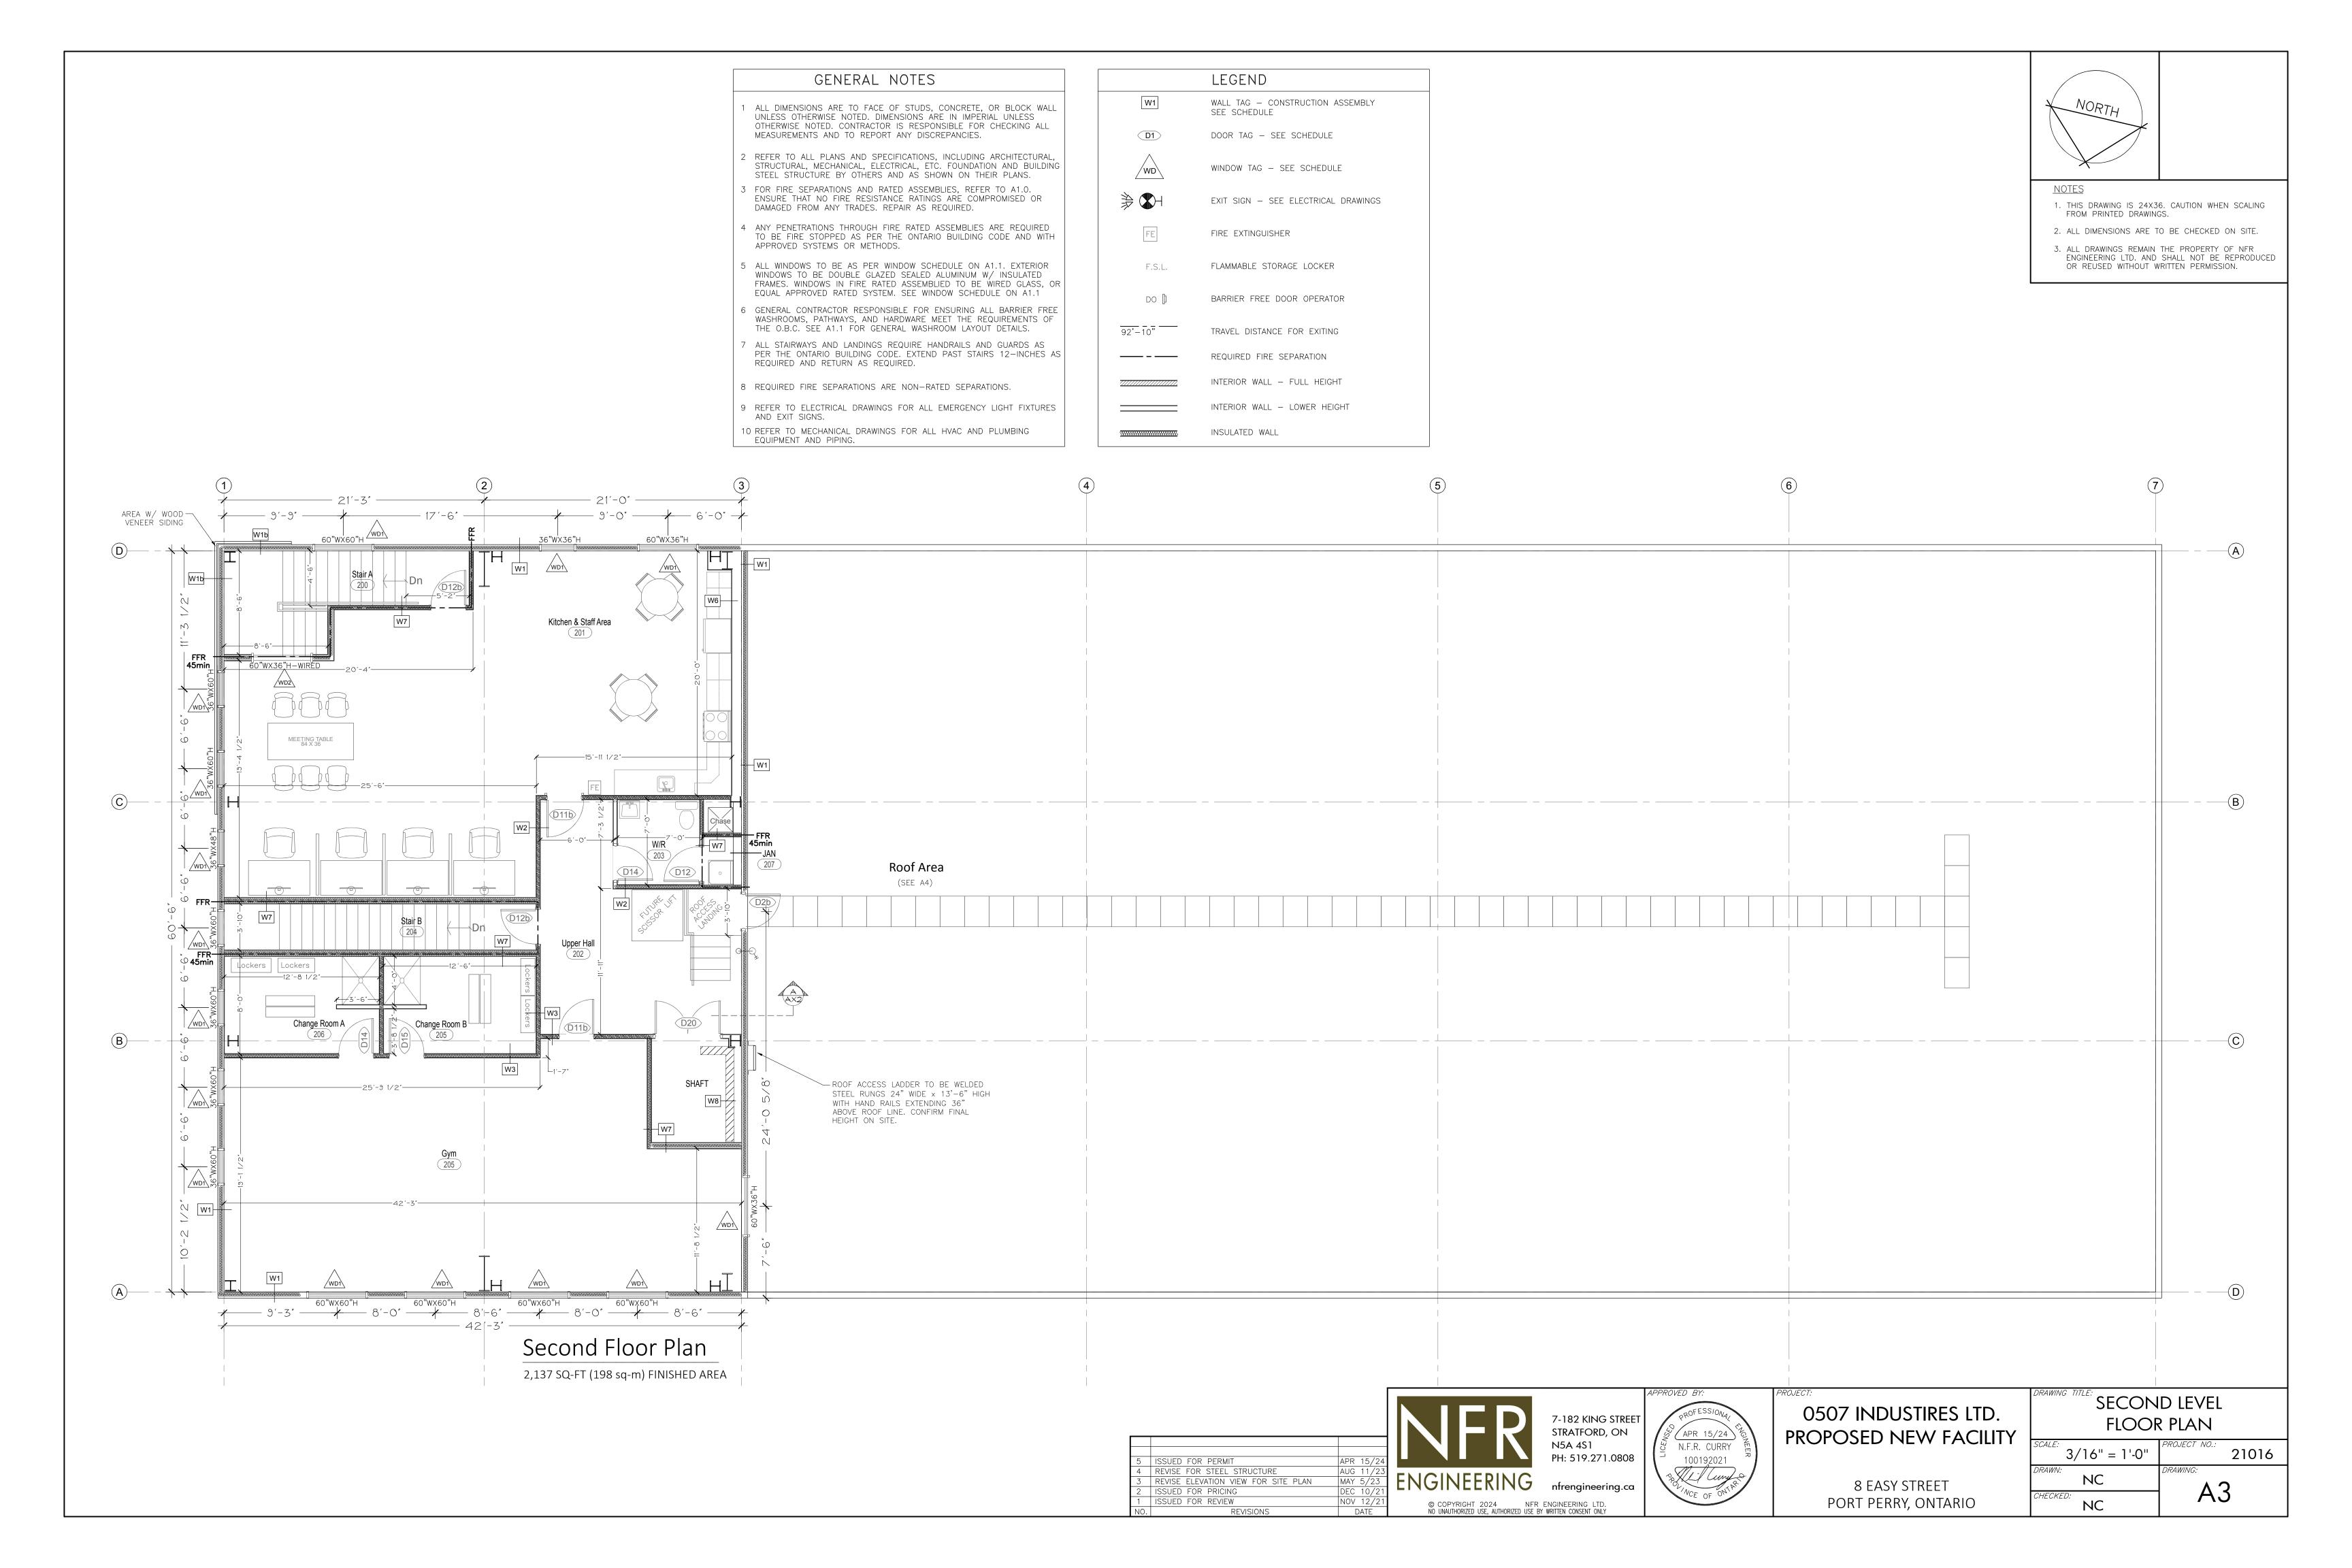

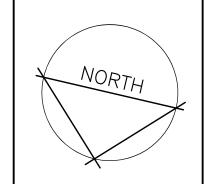

PROPOSED NEW FACILITY

8 EASY STREET

PORT PERRY, ONTARIO

PH: 519.271.0808

ENGINEERING nfrengineering.ca

© COPYRIGHT 2024 NFR ENGINEERING LTD. NO UNAUTHORIZED USE, AUTHORIZED USE BY WRITTEN CONSENT ONLY

3/16" = 1'-0"


NC

NC

21016

A4

- THIS DRAWING IS 24X36. CAUTION WHEN SCALING FROM PRINTED DRAWINGS.
- 2. ALL DIMENSIONS ARE TO BE CHECKED ON SITE.
- 3. ALL DRAWINGS REMAIN THE PROPERTY OF NFR ENGINEERING LTD. AND SHALL NOT BE REPRODUCED OR REUSED WITHOUT WRITTEN PERMISSION.

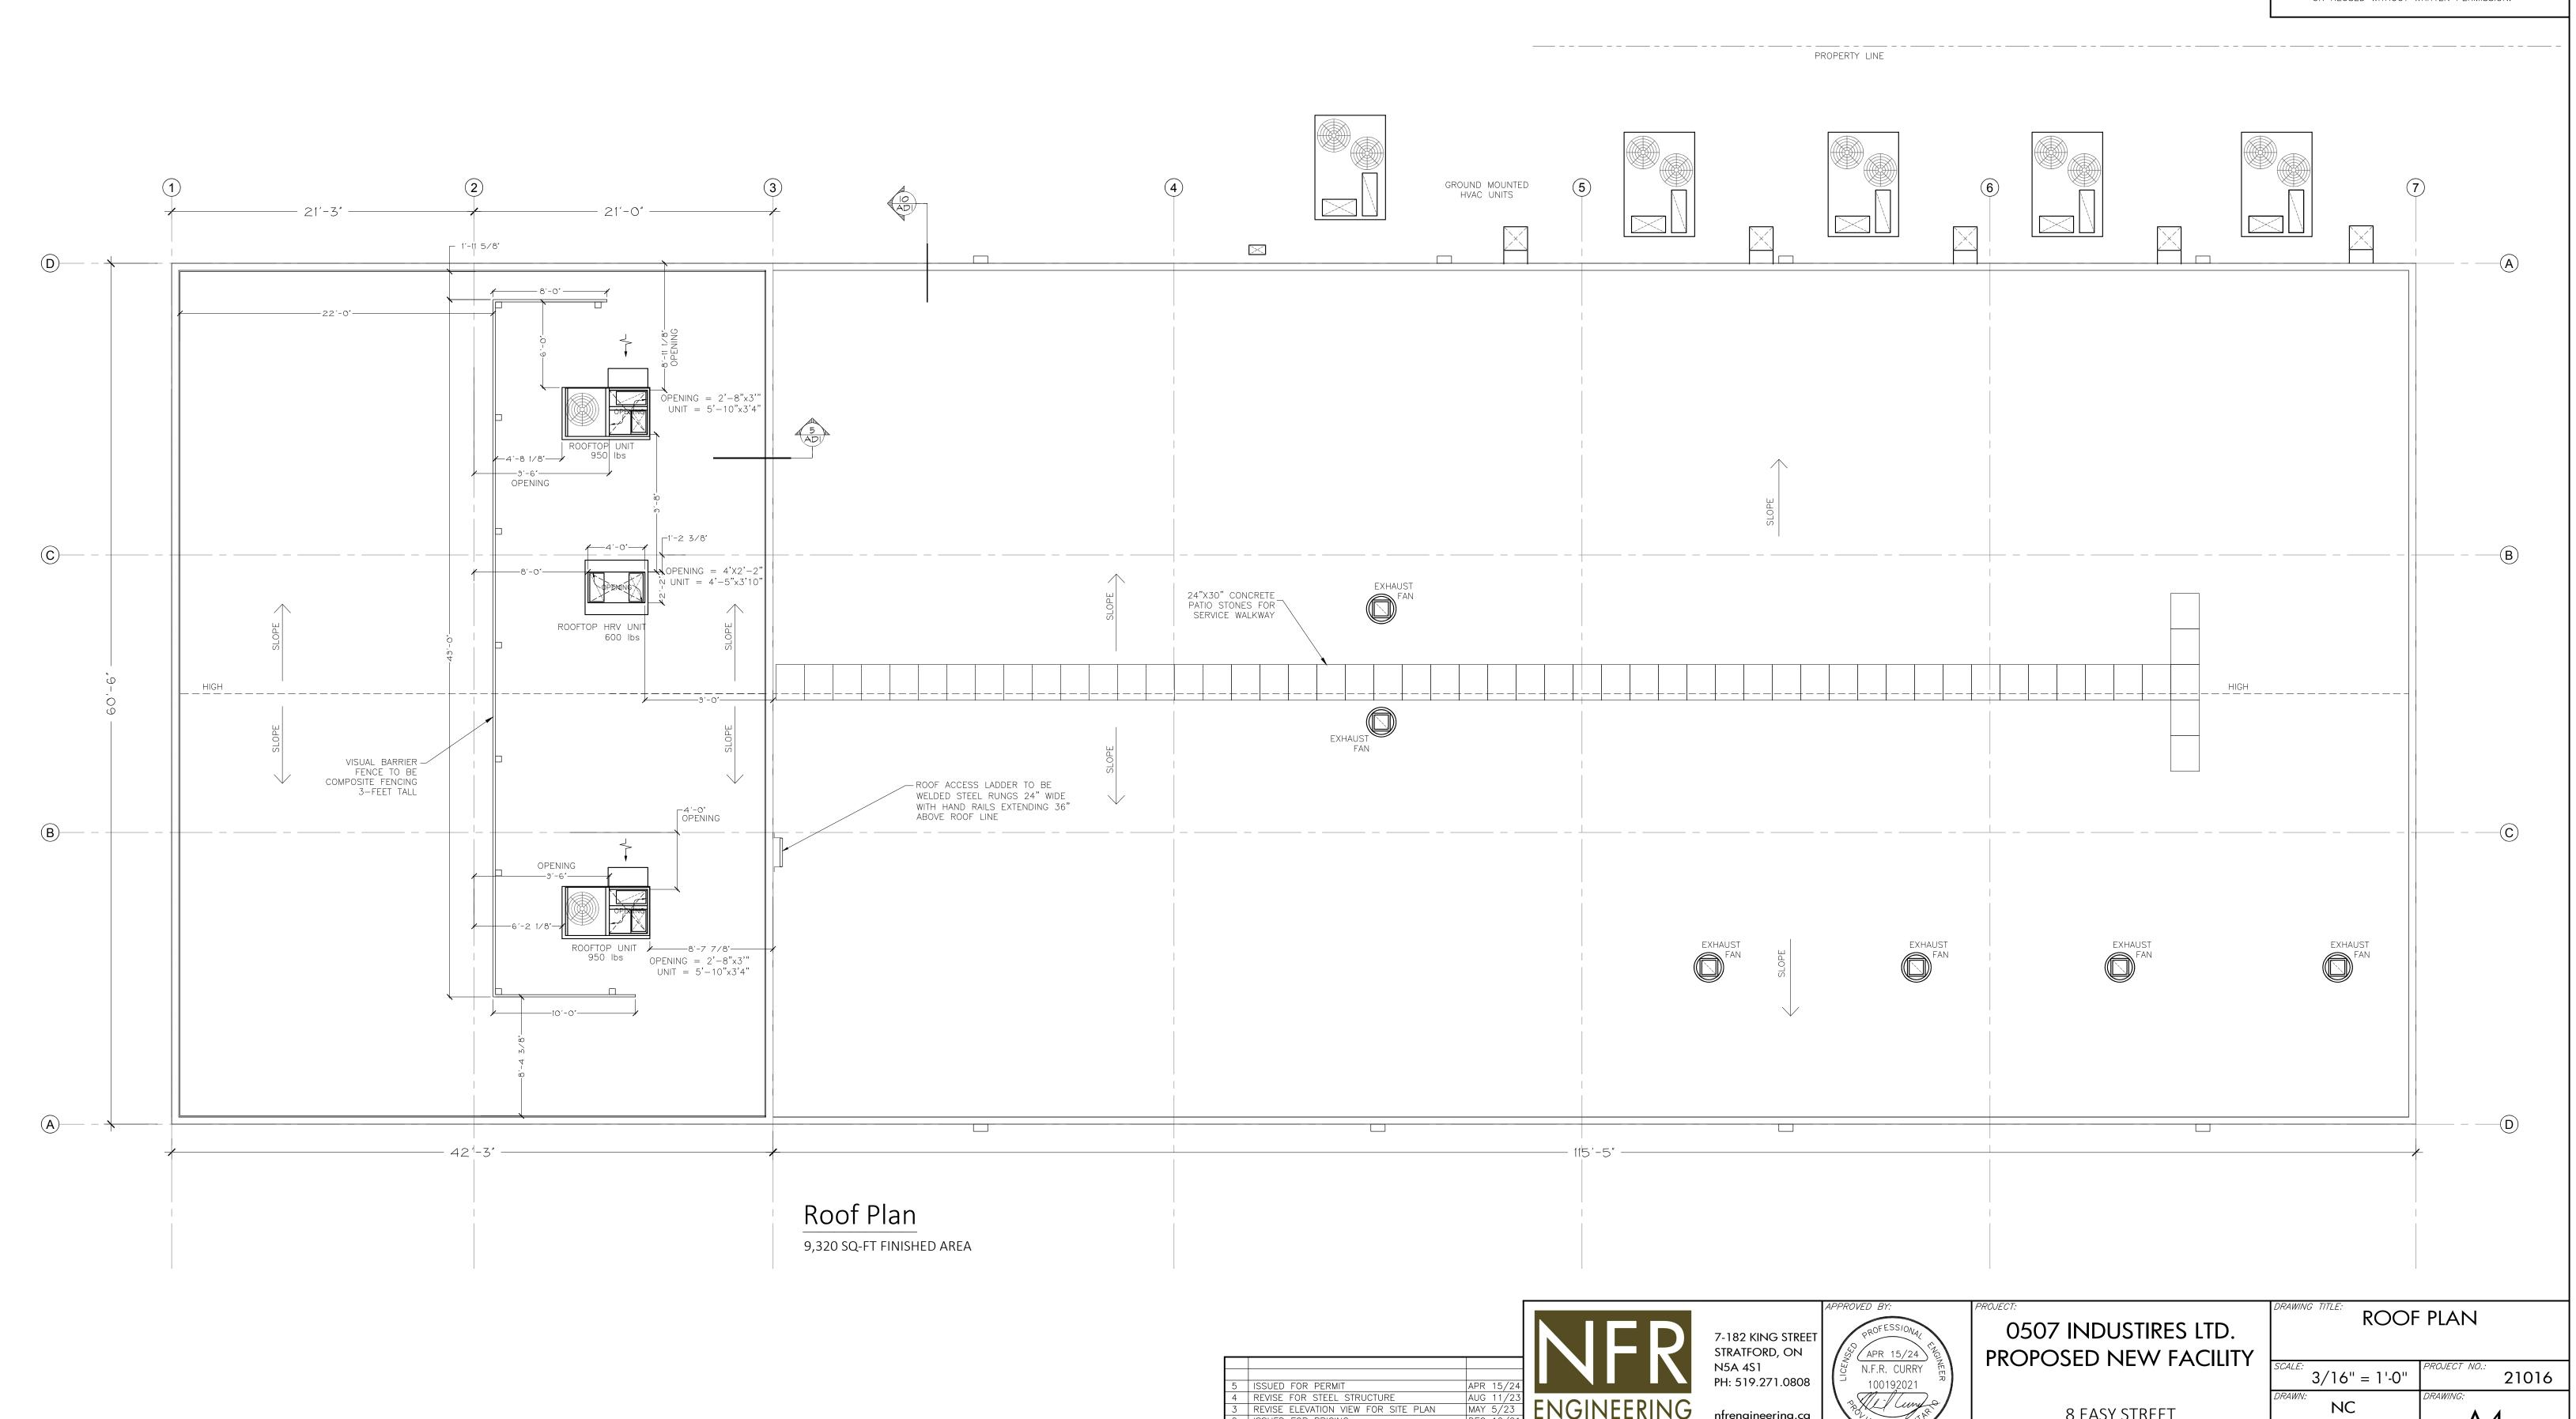

5 ISSUED FOR PERMIT
4 REVISE FOR STEEL STRUCTURE
3 REVISE ELEVATION VIEW FOR SITE PLAN
2 ISSUED FOR PRICING
1 ISSUED FOR REVIEW

