LIST OF DRAWINGS

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CIVIL	
P300	GRADING PLAN
P301	SERVICING PLAN
P302	EROSION AND SEDIMENT CONTROL PLAN
P303	PRE/POST DRAIAGE PLAN

ARCHITECTURAL

, (1 (0) 11 1 20	01012
A000	COVER SHEET
A001	BUILDING CODE MATRIX, LEGEND & ABBREVIATIONS
A003	FIRE SEPARATION PLANS & LD CALCULATIONS
A010	EXTERIOR WALL, PARTITION, FLOOR & ROOF TYPES
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A201	GROUND FLOOR PLAN
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A403	WALL SECTIONS
A404	WALL SECTIONS
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A520	PLAN DETAILS
A524	STANDARD / TYPICAL DETAILS
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A603	EXTERIOR WINDOW SCHEDULE
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S103	ROOF FRAMING PLAN
S201	SCHEDULES & PIER DETAILS
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M-100	GROUND FLOOR MECHANICAL HVAC
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M-300	GROUND FLOOR MECHANICAL SP PLAN
M-301	SECOND FLOOR MECHANICAL SP PLAN
M-400	MECHANICAL ROOF PLAN

=, =,==,=,	
ELECTRICA	\ L
E000	DRAWINGS LIST LEGEND GENERAL NOTES
E001	ELECTRICAL SPECIFICATIONS
E002	SINGLE LINE DIAGRAM
E003	PANEL SCHEDULES
E004	DETAIL SHEET 1
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E102	POWER AND SYSTEMS SECOND FLOOR LAYOUT NOTES
E103	POWER AND SYSTEMS ROOF FLOOR LAYOUT NOTES
E201	LIGHTING AND FIRE ALARM GROUND LAYOUT NOTES
E202	LIGHTING AND FIRE ALARM SECOND LAYOUT NOTES

WAREHOUSE & OFFICE HEADQUARTERS

45 BLOWERS CRES AJAX, ON L1Z 0N4

ISSUED FOR: CLIENT REVIEW 24-07-10



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LANDSCAPE

MARTON SMITH LANDSCAPE ARCHITECTS 170 The Donway W, Suite 206 Toronto ON, M3C 2G3 P: 416-492-9966



STRUCTURAL


AMR ENGINEERING LTD 920 Alness St, Suite 205 Toronto ON, M3J 2H7 P: 416-551-1611



MECHANICAL & ELECTRICAL

FARHEATER ENGINEERING INC. 15 Wertheim Ct, Suite 511 Richmond Hill, ON, L4B 3H7 P: 416-999-2424



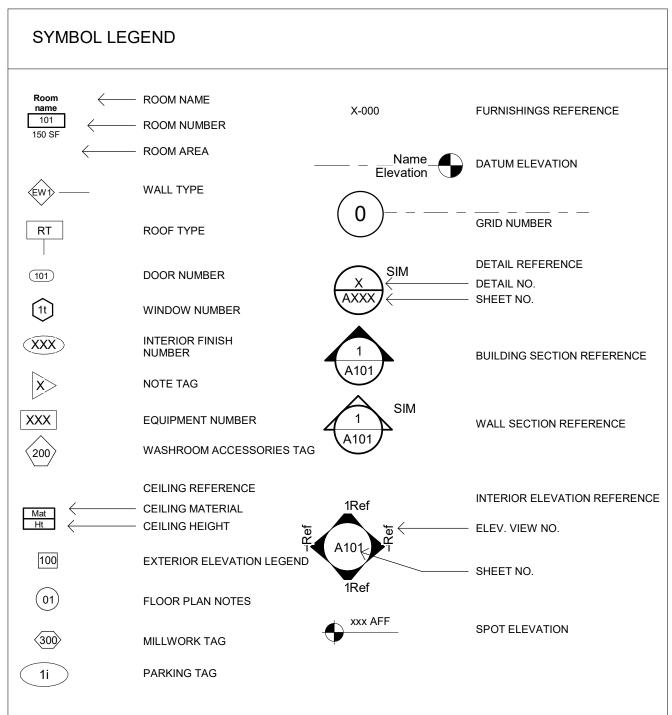

		٠.			
ACT	ACOUSTICAL CEILING TILE SYSTEM	FRP	FIBERGLASS REINFORCED PANEL	PTD	PAINTED
ACC	ACCESSIBLE	FRR	FIRE RESISTANCE RATING	QT	QUARRY TILE
ACM	ALUMINUM COMPOSITE MATERIAL	GALV	GALVANIZED	QTY	QUANTITY
ADO	AUTOMATIC DOOR OPERATOR	G.B.	GYPSUM BOARD	RB	RUBBER
AFF	ABOVE FINISHED FLOOR	GYP. BD.		RD	ROOF DRAIN
AHU	AIR HANDLING UNIT	GC	GENERAL CONTRACTOR	REF	REFRIGERATOR, REFERENCE
ALUM	ALUMINUM	GG	GLASS GUARD	REINF	REINFORCED
ARCH	ARCHITECTURAL, ARCHITECT	H	HIGH	REQD	REQUIRED
ARGB	ABUSE-RESISTANT GYPSUM BOARD		HOSE BIB	REV	REVISION
AUTO	AUTOMATIC	HDW	HARDWARE	RM	ROOM
AVG	AVERAGE	HM		RO	
			HOLLOW METAL		ROUGH OPENING
BD	BOARD	HORIZ	HORIZONTAL	S	SINK
BF	BARRIER FREE	HP	HEAT PUMP	SACT	SUSPENDED ACOUSTICAL TILE
BLDG	BUILDING	HPT	HIGH POINT	SFRM	SPRAY APPLIED CEMENTITIOUS
BSMT	BASEMENT	HSKPG	HOUSEKEEPING		FIRE RESISTIVE MATERIAL
CACF	CENTRAL ALARM AND CONTROL	HT	HEIGHT	SIM	SIMILAR
	FACILITY	HVAC	HEATING, VENTILATION, AIR	SOG	SLAB ON GRADE
C.B.	CONCRETE BLOCK		CONDITIONING	SP	SUMP PUMP
CONC. E		ID	INSIDE DIAMETER	SPEC	SPECIFICATION
CFS	COLD FORMED STEEL	I.D.	INTERIOR DESIGN	SSG	STRUCTURAL SILICONE GLAZING
CG	CORNER GUARD	ICE	ICE MACHINE		STORAGE TANK
CI	CONTINUOUS INSULATION	IGU	INSULATED GLASS UNIT	STC	SOUND TRANSMISSION CLASS
CIP	CAST-IN-PLACE	INSUL	INSULATION	STL	STEEL
CJ	CONTROL JOINT	K.E.S.	KITCHEN EQUIPMENT SUPPLIER	STOR	STORAGE
CL	CENTER LINE	L	LONG	STRUC	STRUCTURAL
C/L		LPT	LOW POINT	Т	TRANSFORMER
CLNG	CEILING	LT	LIGHT	T/	TOP OF
CLR	CLEAR	LVR	LOUVER	T/O	
CMU	CONCRETE MASONRY UNIT	M	METER	TD	TRAVEL DISTANCE
CONC	CONCRETE	MAINT	MAINTENANCE	TEMP	TEMPORARY
CONT	CONTINUOUS	MANUF	MANUFACTURER	THK	THICK
COORD	COORDINATE	MATL	MATERIAL	TPD	TOILET PAPER DISPENSER
CT	CERAMIC TILE	MAX	MAXIMUM	TV	TELEVISION
CU	CONDENSING UNIT	MECH	MECHANICAL	TXT	TEXTURED
C/W	COMPLETE WITH	MEP	MECHANICAL MECHANICAL, ELECTRICAL,	TYP	TYPICAL
CWS	CURTAIN WALL SYSTEM	IVILI	PLUMBING	U/S	UNDER SIDE
D	DRYER DRYER	MEZZ	MEZZANINE	UL	UNDERWRITER'S LABORATORIES
DEG	DEGREE(S)	MH	MANHOLE	0110	ONLEGG NOTEB GITTERWISE
DEMO	DEMOLISH, DEMOLITION	MHO	MAGNETIC HOLD OPEN	VCT	VINYL COMPOSITE TILE
DEPT	DEPARTMENT	MIN	MINIMUM	VEND.	VENDING MACHINE
DW	DISHWASHER	MISC	MISCELLANEOUS	VIF	VERIFY IN FIELD
DWG	DRAWING	MO	MASONRY OPENING	VRF	VARIABLE REFIGERANT FLOW
DWS	DETECTABLE WARNING SURFACE	MTL	METAL	VS	VISION STRIP
EF	EXHAUST FAN	M.U.A.	MAKE-UP AIR	VTAC	VERTICAL TERMINAL AIR
EIFS	EXTERIOR INSULATION FINISH	NIC	NOT IN CONTRACT		CONDITIONER
	SYSTEM	NTS	NOT TO SCALE	VWC	VINYL WALL COVERING
ELEV	ELEVATOR	O.C.	ON CENTER	W/	WITH
EOS	EDGE OF SLAB	O/C		W	WASHER
EQ	EQUAL	OD	OUTSIDE DIAMETER	WC	WATER CLOSET
EQUIP	EQUIPMENT	Р	PANEL	W/D	STACKED WASHER AND DRYER
ETC	ET CETERA	PCT	PORCELAIN CERAMIC TILE	WD	WOOD
EX	EXISTING	PDO	POWER DOOR OPERATOR	WIC	WALK IN CLOSET
EXIST		PLAM	PLASTIC LAMINATE	WR	WASHROOM
EXP JT	EXPANSION JOINT	PLYWD	PLYWOOD	WWM	WELDED WIRE MESH
EXT	EXTERIOR	PREFAB	PREFABRICATED	X	BY
F	FREEZER	PROP	PROPERTY		
F/A	FIRE ALARM	PSH	PURSE SHELF		
FHC	FIRE HOSE CABINET	PTAC	PACKAGED TERMINAL AIR		
FEC	FIRE EXTINGUISHER CABINET				

SUPPI ENER	ry of Municipal Aff LEMENTARY STAN GY EFFICIENCY RI 2012 (2017 AMENDI	IDARD SB-10: EQUIREMENTS			THERI	RMAL INSULATION REQUIREMENTS CLIMATE ZONE 5 TABLE SB5.5-5-2017							
			NON-RESIDENTIAL				RES	SIDENTI	AL	SEI	MIHEATE	:D	
OPAQUE ENVELOPE ELEMENTS		· · · · · · · · · · · · · · · · · · ·	INSULATION MIN. R-VALUE			INSULATION MIN. R-VALUE			INSULATION MIN. R-VALUE				
***************************************		·	REQ'D		PR	OVIDED	REQ'D	PR	OVIDED	REQ'D	PR	OVIDED	
		INSULATION ENTIRELY ABOVE DECK	R-35.0 c	i	R-	35.0 ci	R-35.0 c	i	NR	R-17 ci		NR	
ROOFS		METAL BUILDING											
		ATTIC & OTHER											
		MASS	R-17.0 c	i	R-	17.0 ci	R-19.0 c	i	NR				
	ABOVE GRADE	METAL BUILDING											
<u>WALLS</u>		STEEL FRAME	R-13 +R-12	2 ci	R-13	+R-12 ci	R-13 +R-12	ci NR					
		WOOD FRAMED & OTHER											
	BELOW GRADE	BELOW GRADE WALL	R-15.0 ci	1	R-	15.0 ci	R-15.0 ci	i	NR	R-7.4 ci		NR	
•		MASS		\dashv									
FLOORS	<u>.</u>	STEEL JOIST	R-38		R-38		R-38		NR	R-21		NR	
		WOOD FRAMED & OTHER											
SLAB-ON	N-GRADE	UNHEATED	R-15 FOR 48IN R-15 FOR 48IN		R-15 FOR 48IN NR		NR	R-15 FOR 48	BIN	NR			
FLOORS		HEATED											
		SWINGING	U-0.45	\dashv	U	-0.45	U-0.45		NR				
<u>OPAQUE</u>	DOORS	NONSWINGING	U-0.45		U-0.45		U-0.45		NR				
			AS	SSEN	MBLY		ASSEMBLY		,	А	SSEMBLY	SEMBLY	
FENEST	RATION		MAX. U-VALUE		AX. IGC	MAX. VT/SHGC	MAX. U-VALUE	MAX. SHGC	MAX. VT/SHGC	MAX. U-VALUE	MAX. SHGC	MAX. VT/SHG0	
		NONMETAL FRAMING: ALL	U-0.29				U-0.29		3	U-0.41			
Vertical Fenestration, 0% - 40% of Wall		METAL FRAMING: FIXED	U-0.38				U-0.38			U-0.56			
		METAL FRAMING: OPERABLE	U-0.45	0.	.40	1.10	U-0.45	0.40	1.10	U-0.63	NR	NR	
		METAL FRAMING: ENTRANCE DOOR	U-0.69				U-0.61			U-0.69			
Skylight, 0% - 3% of Roof		ALL TYPES	U-0.45	0.	.40	NR	U-0.45	0.40	NR	U-0.88	NR	NR	

*ci = continuous insulation, *Ls = liner system, *NR = no requirement

Name of Practice: SAPLYS ARCHITECTS INCORPORATED Name of Project: 60 ST. CLAIR AVE E, SUITE 806 WAREHOUSE AND OFFICE HEADQUARTERS OAKVILLE, ONTARIO L6J 7W4 P: 416.771.6460 45 BLOWERS CRES, AJAX, ON L1Z 0N4 25 APR, 2024 Building Code Reference 1 Ontario Building Code Data Matrix - Part 3 BUILDING CODE VERSION: O. Reg. 332/12 Last Amendment O. Reg. 89/23 3.01 PROJECT TYPE: ADDITION RENOVATION [A] 1.1.2. NEW ☐ CHANGE OF USE ☐ ADDITION AND RENOVATION DESCRIPTION:WAREHOUSE WITH ANCILLARY OFFICE SPACE 3.02 MAJOR OCCUPANCY 3.1.2.1.(1) OCCUPANCY <u>USE</u> CLASSIFICATION: MEDIUM HAZARD INDUSTRIAL - Group - F2 STORAGE SPACE BUSINESS & PERSONAL SERVICES - Group D OFFICE SPACE 3.2.2.7. 3.03 SUPERIMPOSED ■ NO □ YES MAJOR OCCUPANCIES: 3.04 BUILDING AREA DESCRIPTION: **EXISTING** <u>NEW</u> <u>TOTAL</u> [A] 1.4.1.2. 1768.50 m² 1768.50 m² 3.05 GROSS AREA **EXISTING** [A] 1.4.1.2. DESCRIPTION: NEW <u>TOTAL</u> 1ST STOREY N/A 1768.50 m² 1768.50 m² 2ND STOREY N/A 354.00 m² 354.00 m² TOTAL N/A 2122.50 m² 2122.50 m² 3.2.1.1. 3.06 MEZZANINE **EXISTING** <u>TOTAL</u> DESCRIPTION: <u>NEW</u> AREA (M2) _____2 _STOREYS ABOVE GRADE _____0 ___ STOREYS BELOW GRADE ______10.60 ____ (M) ABOVE GRADE ______ T/O ROOF DECK [A] 1.4.1.2. & 3.2.1.1. 3.07 BUILDING 3.08 HIGH BUILDING ■ NO □ YES 3.2.6. 3.2.2.10. & 3.2.5. 3.09 NUMBER OF STREETS/ ___1_ STREET FIREFIGHTER ACCESS 3.10 BUILDING CLASSIFICATION: 3.2.2.70 Group F, Division 2, up to 4 Storeys 3.2.2.23 (SIZE AND CONSTRUCTION 3.2.2.42 3.2.2.56. Group D, up to 2 Storeys, Sprinklered RELATIVE TO OCCUPANCY) 3.2.1.5. & 3.11 SPRINKLER SYSTEM ☐ NOT REQUIRED ☐ SELECTED COMPARTMENTS ENTIRE BUILDING ☐ SELECTED FLOOR AREAS ☐ IN LIEU OF ROOF RATING ■ NONE 3.2.9. 3.12 STANDPIPE REQUIRED NOT REQUIRED SYSTEM 3.13 FIRE ALARM SYSTEM REQUIRED NOT REQUIRED ☐ TWO STAGE PROPOSED: ☐ SINGLE STAGE ☐ NONE 3.14 WATER SERVICE / 1 NZ SUPPLY IS ADEQUATE RESTRICTION: COMBUSTIBLE PERMITTED 3.15 CONSTRUCTION TYPE: 3.2.2.20. - 83. & 3.2.1.4. ☐ NON-COMBUSTIBLE REQUIRED ☐ COMBUSTIBLE NON-COMBUSTIBLE COMBINATION ■ NO □ YES 4.1.2.1.(3) & T4.1.2.1.B 3.16 IMPORTANCE ☐ LOW □ LOW HUMAN OCCUPANCY
□ POST-DISASTER SHELTER CATEGORY: NORMAL ☐ HIGH ☐ MINOR STORAGE BUILDING ☐ EXPLOSIVE OR HAZARDOUS SUBSTANCES ☐ POST-DISASTER 3.17 SEISMIC (IE FA SA (0.2)) = 0.1784.1.2.1.(3) SEISMIC DESIGN REQUIRED FOR TABLE 4.1.1.18. ITEMS 6 TO 21: HAZARD INDEX 4.1.8.18.(2) ((IE FA SA (0.2)) ≥ 0.35 OR POST-DISASTER) ☐ NO YES 3.18 OCCUPANT OCCUPANT LOAD 3.1.17. OCCUPANCY BASED ON FLOOR LEVEL/AREA TYPE (PERSONS) GROUND FLOOR (WAREHOUSE) - Staff GROUND FLOOR (OFFICE) By design 12 2nd FLOOR (OFFICE) By design TOTAL 20 persons 3.19 BARRIER-FREE **EXPLANATION** □ NO BARRIER-FREE ENTRANCES 3.20 HAZARDOUS 3.3.1.2. & ☐ YES **EXPLANATION** SUBSTANCES: ■ NO HORIZONTAL ASSEMBLY 3.21 REQUIRED FIRE SUPPORTING NONCOMBUSTIBLE 3.2.2.20. - 83. **RATING** RESISTANCE <u>ASSEMBLY</u> IN LIEU OF RATING? & 3.2.1.4. RATINGS FLOORS (OFFICE) ☐ NO ■ YES ☐ N/A □ NO □ YES ■ N/A MEZZANINE ROOF NO □ NO □ YES ■ N/A L/H OR REQUIRED <u>CONSTRUCTION</u> H/L FRR (H) <u>TYPE REQUIRED</u> EBF AREA L.D. 3.22 SPATIAL SEPARATION (M2) <u>(M)</u> FRR (H) 0HR ■ NONCOMBUSTIBLE ■ NONCOMBUSTIBLE North (FC-1) 448 >15 m OHR ■ NONCOMBUSTIBLE ■ NONCOMBUSTIBLE South (FC-1) 501 OHR ■ NONCOMBUSTIBLE ■ NONCOMBUSTIBLE 304.9 12.88 m 0HR ■ NONCOMBUSTIBLE ■ NONCOMBUSTIBLE West (FC-1) 239.3 3 m 0HR ■ NONCOMBUSTIBLE ■ NONCOMBUSTIBLE West (FC-2) 65.5 >15 m 3.23 PLUMBING RATIO: MALE:FEMALE = 50:50 EXCEPT AS NOTED OTHERWISE FIXTURE REQUIREMENTS FLOOR LEVEL/AREA OCCUPANT LOAD OBC REFERENCE FIXTURES REQUIRED FIXTURES PROVIDED 2(MALE), 2(FEMALE) 1/1 UNISEX (G.F & S.F) 1/1 UNIVERSAL 1/1 BARRIER-FREE WAREHOUSE (G.F) 1(MALE), 1(FEMALE) 1/1 UNISEX 3.7.4.9. 3.24 ENERGY COMPLIANCE PATH: PRESCRIPTIVE COMPLIANCE EFFICIENCY: CLIMATIC ZONE: 6 BUILDING ENVELOPE COMPLY WITH REQUIREMENT OF OBC TABLE SB 5.5-6 -2017 OF SB-10 (ELECTRIC HEATING USE) 3.24 NOTE: SCALE:

NOT ISSUED FOR CONSTRUCTION

DO NOT SCALE DRAWINGS. USE ONLY DRAWINGS MARKED "ISSUED FOR CONSTRUCTION". VERIFY CONFIGURATIONS & DIMENSIONS ON SITE BEFORE BEGINNING WORK. NOTIFY ARCHITECT IMMEDIATELY OF ANY ERRORS, OMISSIONS OR DISCREPANCIES.

CLIENT REVIEW

ISSUANCE SCHEDULE

24-07-10

YY-MM-DD

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SCARBOROUGH, ON M1X 1G5



API

CONSULTANTSING



WAREHOUSE & OFFICE HEADQUARTERS

45 BLOWERS CRES AJAX, ON L1Z 0N4

BUILDING CODE MATRIX, LEGEND & ABBREVIATIONS

BY CHECK ISSUED FOR AGR NZ CLIENT REVIEW PROJECT NO.: SHEET NO.: A22-018

1/4" = 1'-0"


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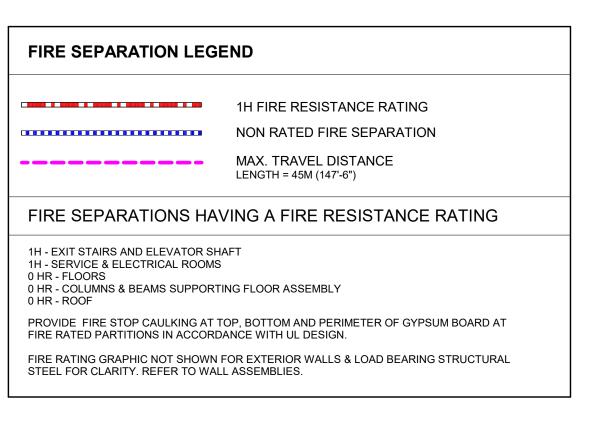
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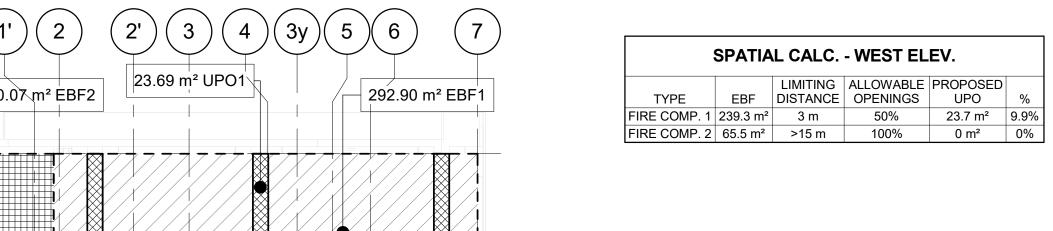
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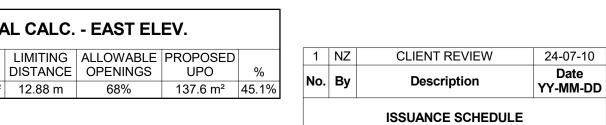
OBC MATRIX

1/4" = 1'-0"








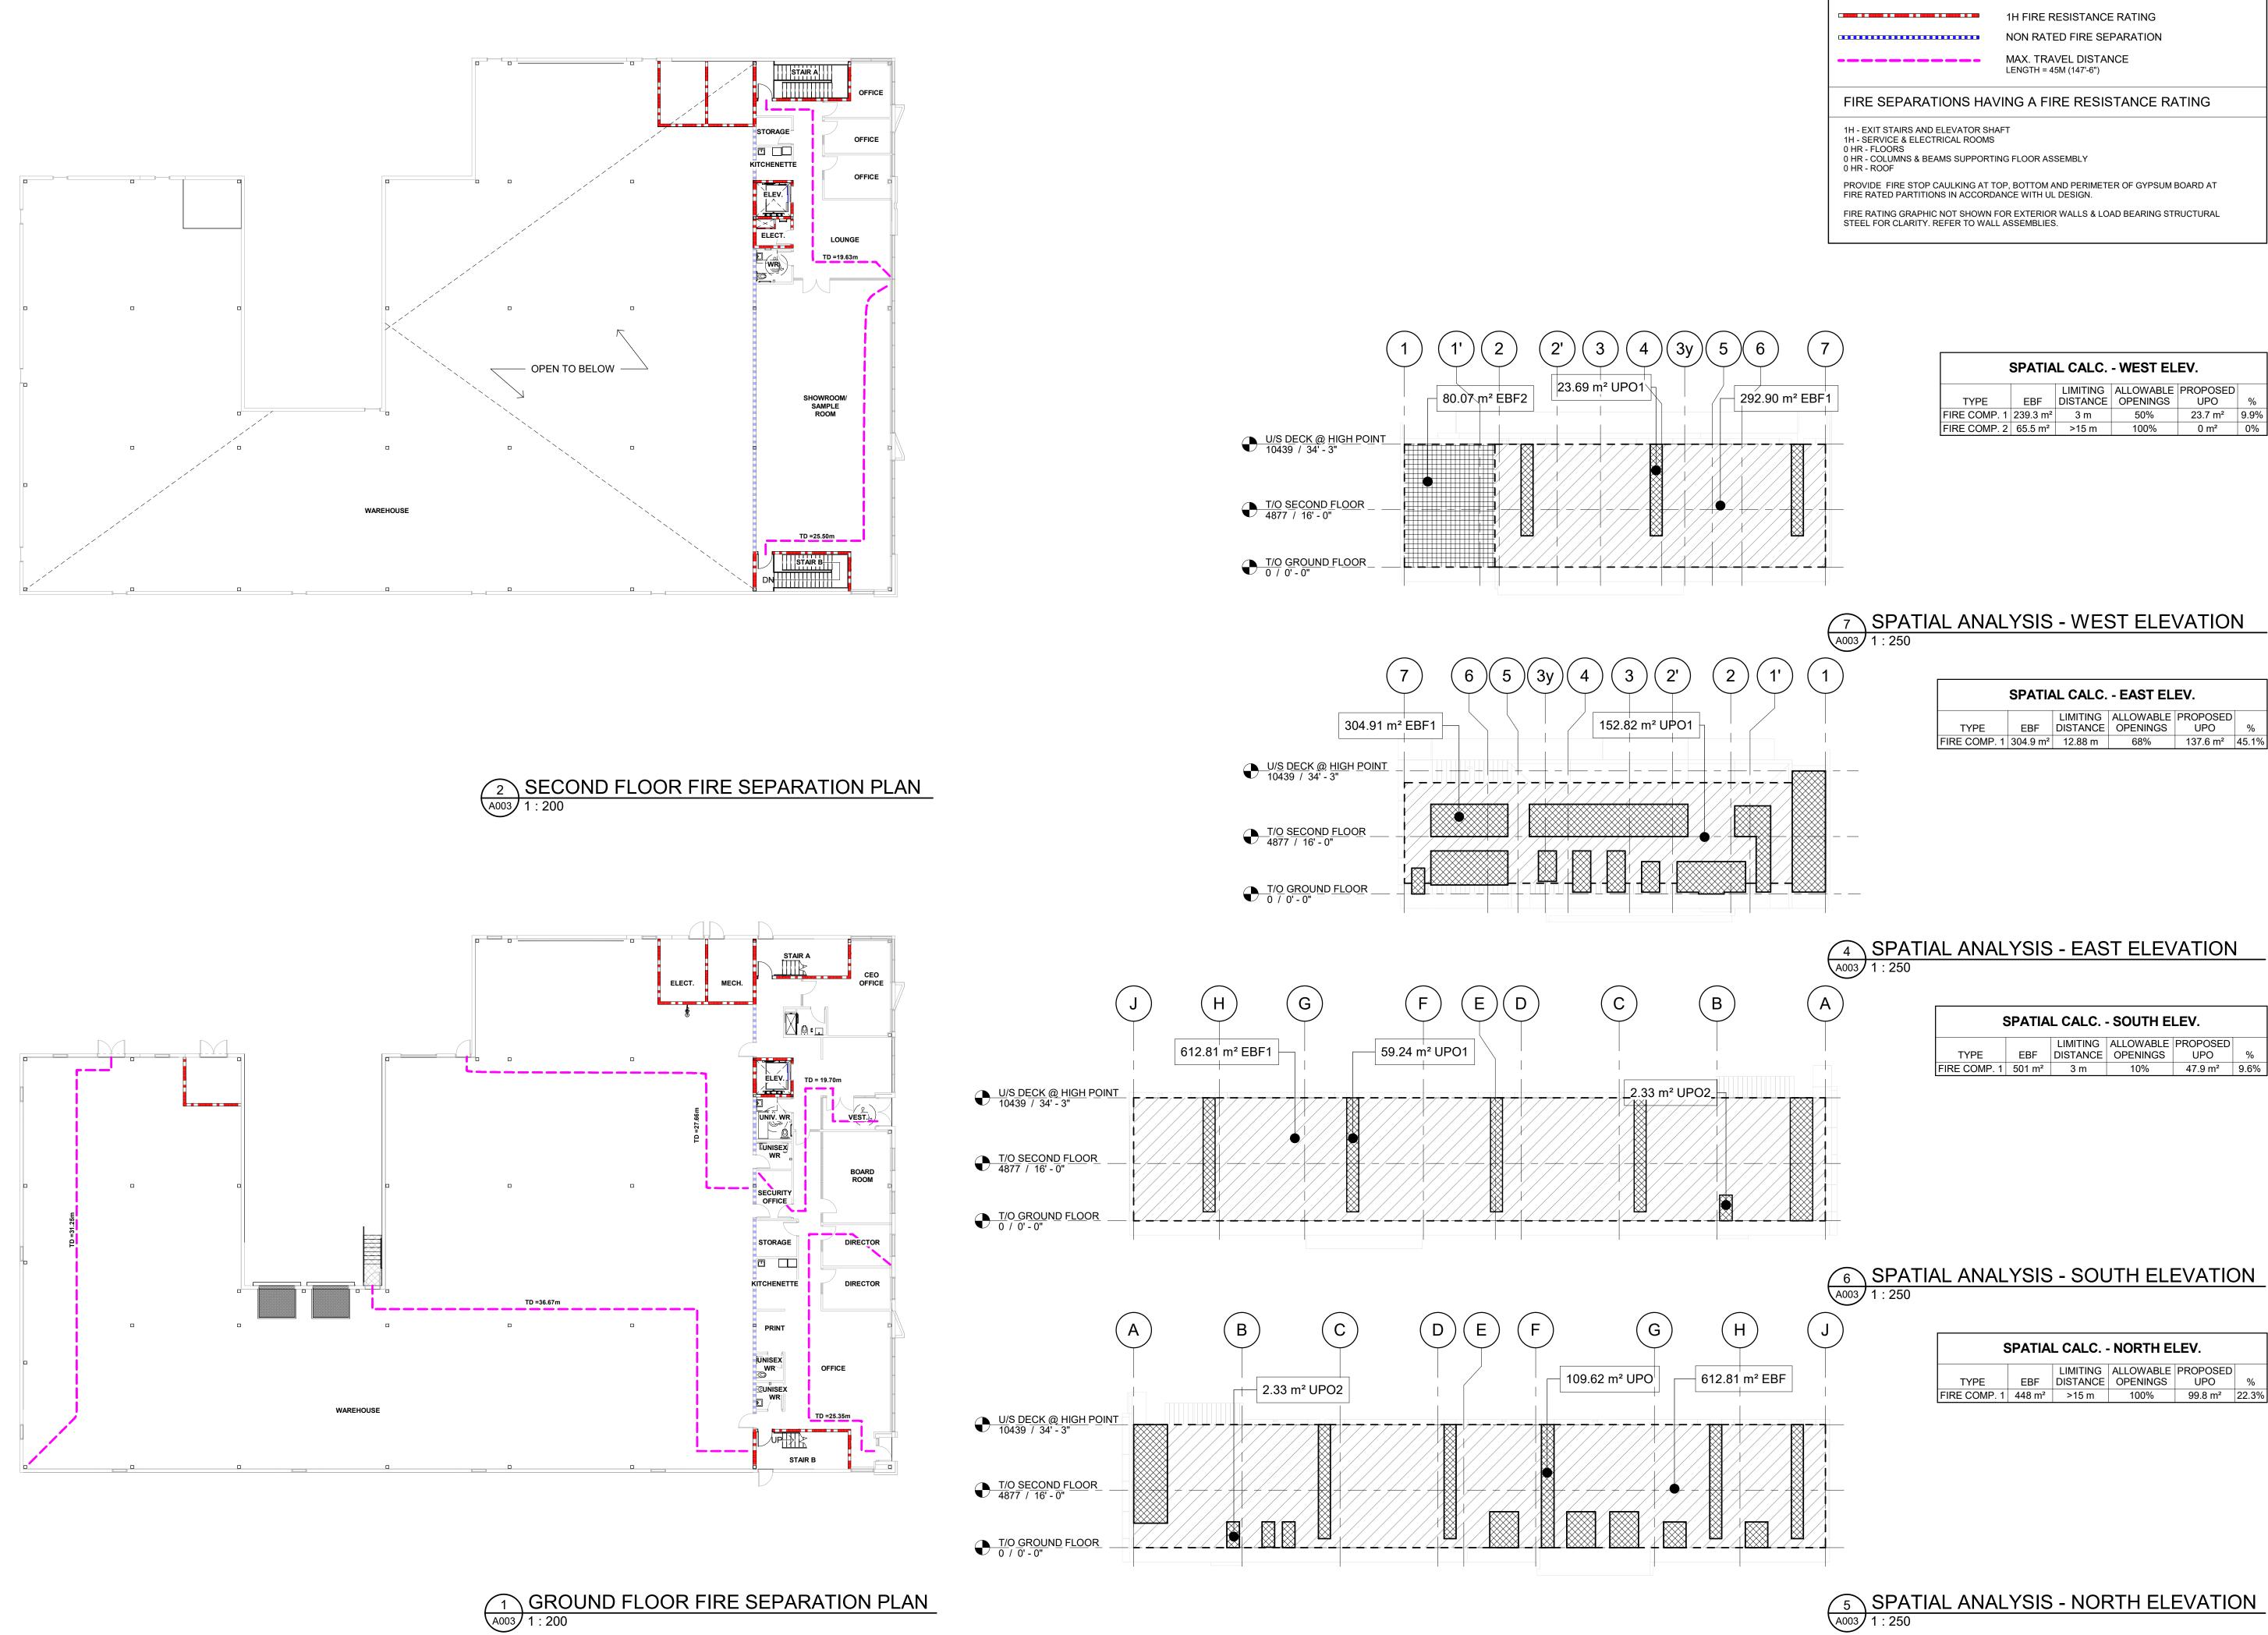

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1464 CORNWALL ROAD, UNIT 8 OAKVILLE, ONTARIO L6J 7W5 SAPLUS ARCHITECTS

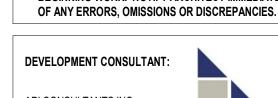CLIENT: STARNIGHT IMPORT & EXPORT 35B IRONSIDE CRESCENT SCARBOROUGH, ON M1X 1G5

ST R



WAREHOUSE & OFFICE **HEADQUARTERS**

45 BLOWERS CRES AJAX, ON L1Z 0N4

FIRE SEPARATION PLANS & LD CALCULATIONS


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As indicated


ISSUE DATE: **24-07-10**

EW - EXTERIOR WALL TYPES GENERAL



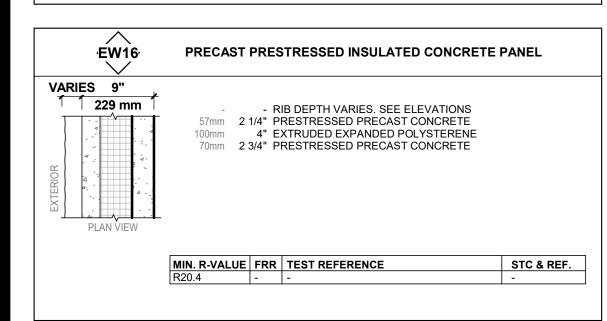

FW - FOUNDATION WALL TYPES

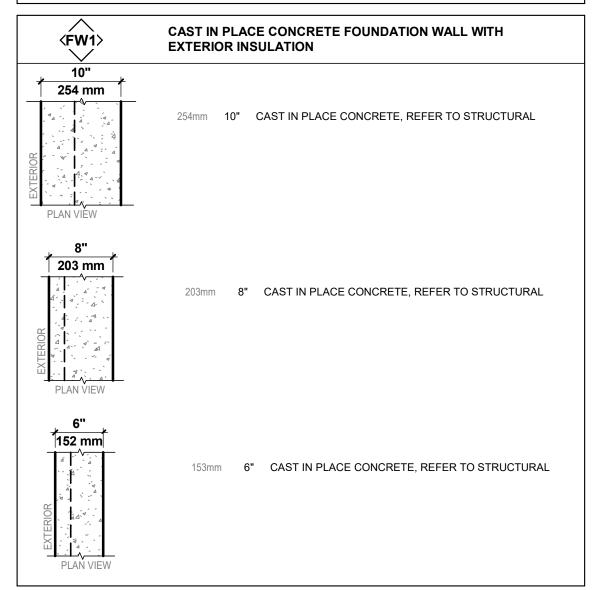

P - PARTITION TYPES FURRING

SINGLE SIDED INTERIOR PARTITION 3" 76 mm 13mm 1/2" GYPSUM BOARD 64mm 2 1/2" STEEL STUDS @ 16"/ 406mm O/C STC TEST REF. FRR TEST REFERENCE 92mm 3 5/8" STEEL STUDS @ 16"/ 406mm O/C FRR TEST REFERENCE STC TEST REF.


P - PARTITION TYPES NON LOAD-BEARING


DOUBLE SIDED INTERIOR PARTITION 178 mm 13mm 1/2" GYPSUM BOARD 152mm 6" STEEL STUDS @ 16"/ 406mm O/C 13mm 1/2" GYPSUM BOARD FRR TEST REFERENCE STC TEST REF. 9" SIMILAR: 16mm 16mm 5/8" GYPSUM BOARD 152mm 8" STEEL STUDS @ 16"/ 406mm O/C 16mm 5/8" GYPSUM BOARD FRR | TEST REFERENCE STC TEST REF. 16mm 5/8" GYPSUM BOARD **⟨P20E⟩** 152mm 8" STEEL STUDS @ 16"/ 406mm O/C

16mm 5/8" GYPSUM BOARD


STC TEST REF.

FRR TEST REFERENCE

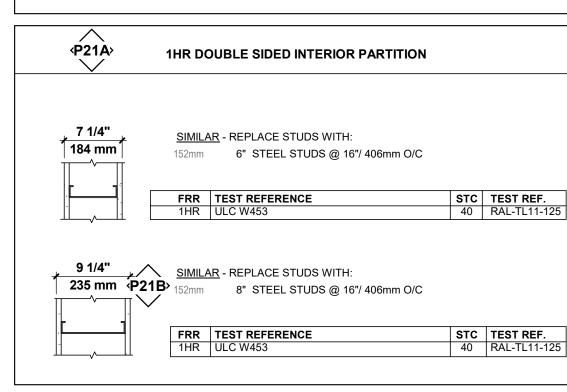

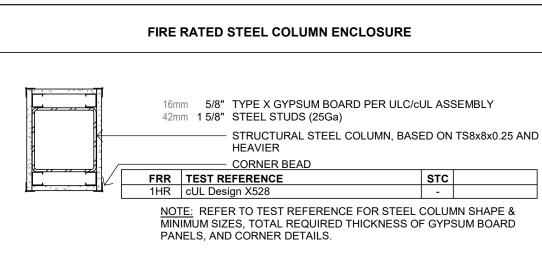


F - FLOOR TYPES

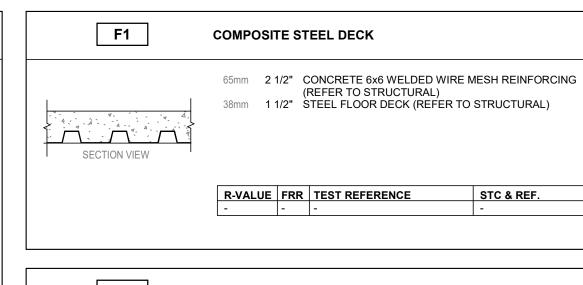


F3 CONCRETE SLAB ON GRADE FLOOR FINISH (REFER TO INTERIOR DESIGN) 6" REINFORCED CONCRETE SLAB (REFER TO STRUCTURAL TO CONFIRM DEPTH, REINFORCING & 10MIL POLYETHYLENE VAPOUR RETARDER 3" HIGH DENSITY EXTRUDED POLYSTYRENE (XPS) RIGID INSULATION (MIN R15 CI) 5" COMPACTED GRANULAR (REFER TO STRUCTURAL) SECTION VIEW NOTE: REFER TO GEOTECHNICAL / SOILS REPORT FOR ADDITIONAL REQUIREMENTS & RECOMMENDATIONS R-VALUE FRR TEST REFERENCE

R - ROOF TYPES

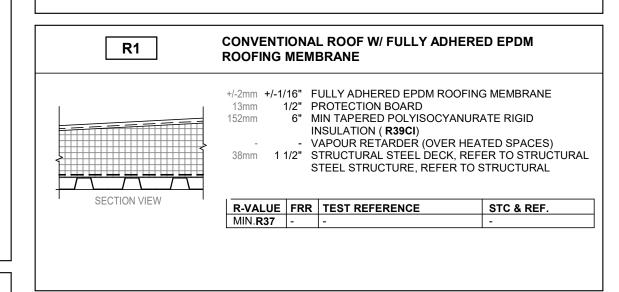

P - PARTITION TYPES SHAFT WALL

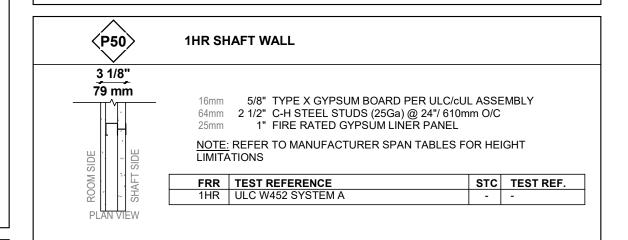

WALL & PARTITION TYPE NOTES

- 1. CONFIRM & COORDINATE ALL STUD WALL VERTICAL SPAN / HEIGHT LIMITATIONS WITH
- GYPSUM WALL BOARD TRADE. CONTRACTOR TO COORDINATE LOCATION OF WALL BLOCKING AND SHEET METAL OR PLYWOOD REINFORCING FOR WALL MOUNTED EQUIPMENTS WIH ARCHITECTURAL
- 3. COMBUSTIBLE MATERIALS SHALL COMPLY WITH OBC 2012 ARTICLE 3.1.5.12 4. EXTEND GYPSUM BOARD 8" ABOVE CEILING ON GROUND FLOOR.
- STUDS TO BE MAX. 16 INCH O.C. UNLESS OTHERWISE NOTED.
- 6. WALLS TO BE CONSTRUCTED AS A GUARDS WHERE FLOOR ELEVATION DIFFERENCE IN LEVEL IS MORE THAN 600MM BETWEEN THE WALKING SURFACE AND THE ADJACENT SURFACE. (OBC 3.4.6.6 (1)(a)) (TYPICAL AT FLOOR OPENINGS)

- WASHROOMS CONTAINING SHOWER:
 PROVIDE MOISTURE, MOLD AND MILDEW RESISTANT GYPSUM BOARD ON WALLS AND CEILING FOR PAINTED SURFACES.
- 8. PROVIDE MOISTURE, MOLD AND MILDEW RESISTANT CEMENT BOARD BACKING FOR ALL TILE. TYPE: "CGC Durock®" CEMENT BOARD OR APPROVED EQUAL.

9. WHERE FURRING CHANNELS ARE TO BE USED, PROVIDE GALVANIZED STEEL STUDS. FIRE RATED ASSEMBLIES:

10. PROVIDE FIRE STOP CAULKING AT TOP, BOTTOM AND PERIMETER OF GYPSUM BOARD AT

- FIRE RATED PARTITIONS IN ACCORDANCE WITH ULC/cUL DESIGN. 11. PROVIDE MOISTURE, MOLD & MILDEW RESISTANT GYPSUM BOARD AT ALL WASHROOM SHOWER ENCLOSURES. ENSURE GYPSUM BOARD TYPE COMPLIANT WITH ULC/cUL ASSEMBLY
- WHERE APPLICABLE. 12. PROVIDE ULC/cUL CERTIFIED FIRE STOPPING MATERIAL AT ALL WALL PENETRATIONS TO
- MAINTAIN CONTINUITY OF FIRE SEPARATION. 13. EXTEND GYPSUM BOARD TO U/S OF SLAB C/W PERIMETER SMOKE SEAL CAULKING AT 0HR / SMOKE SEAL LOCATIONS, TYPICAL.

- 14. EXTEND GYPSUM BOARD TO U/S OF DECK C/W PERIMETER ACOUSTICAL SEALANT AT STC RATED PARTITIONS
- 15. PROVIDE CONTINUOUS STC RATED WALLS SEPARATING EITHER OFFICES, PUBLIC WASHROOMS, OR MEETING/CONFERENCE ROOMS FROM PUBLIC AREAS.



1 NZ **CLIENT REVIEW**

ISSUANCE SCHEDULE

DO NOT SCALE DRAWINGS. USE ONLY DRAWINGS MARKED "ISSUED FOR CONSTRUCTION". VERIFY CONFIGURATIONS & DIMENSIONS ON SITE BEFORE BEGINNING WORK. NOTIFY ARCHITECT IMMEDIATELY OF ANY ERRORS, OMISSIONS OR DISCREPANCIES.

DEVELOPMENT CONSULTANT:

API CONSULTANTS INC. 1464 CORNWALL ROAD, UNIT 7 OAKVILLE, ONTARIO L6J 7W5



24-07-10

YY-MM-DD

ARCHITECT:

P: 905.337.7249

SAPLYS ARCHITECTS INC. 1464 CORNWALL ROAD, UNIT 8 OAKVILLE, ONTARIO L6J 7W5

SCARBOROUGH, ON M1X 1G5



CLIENT: STARNIGHT IMPORT & EXPORT 35B IRONSIDE CRESCENT





PROFESSIONAL CERTIFICATION


WAREHOUSE & OFFICE **HEADQUARTERS**


> **45 BLOWERS CRES** AJAX, ON L1Z 0N4

EXTERIOR WALL, PARTITION, FLOOR & **ROOF TYPES**

BY | CHECK | ISSUED FOR AGR NZ CLIENT REVIEW PROJECT NO.: | SHEET NO.: A22-018 SCALE:

1" = 1'-0" ISSUE DATE: 24-07-10

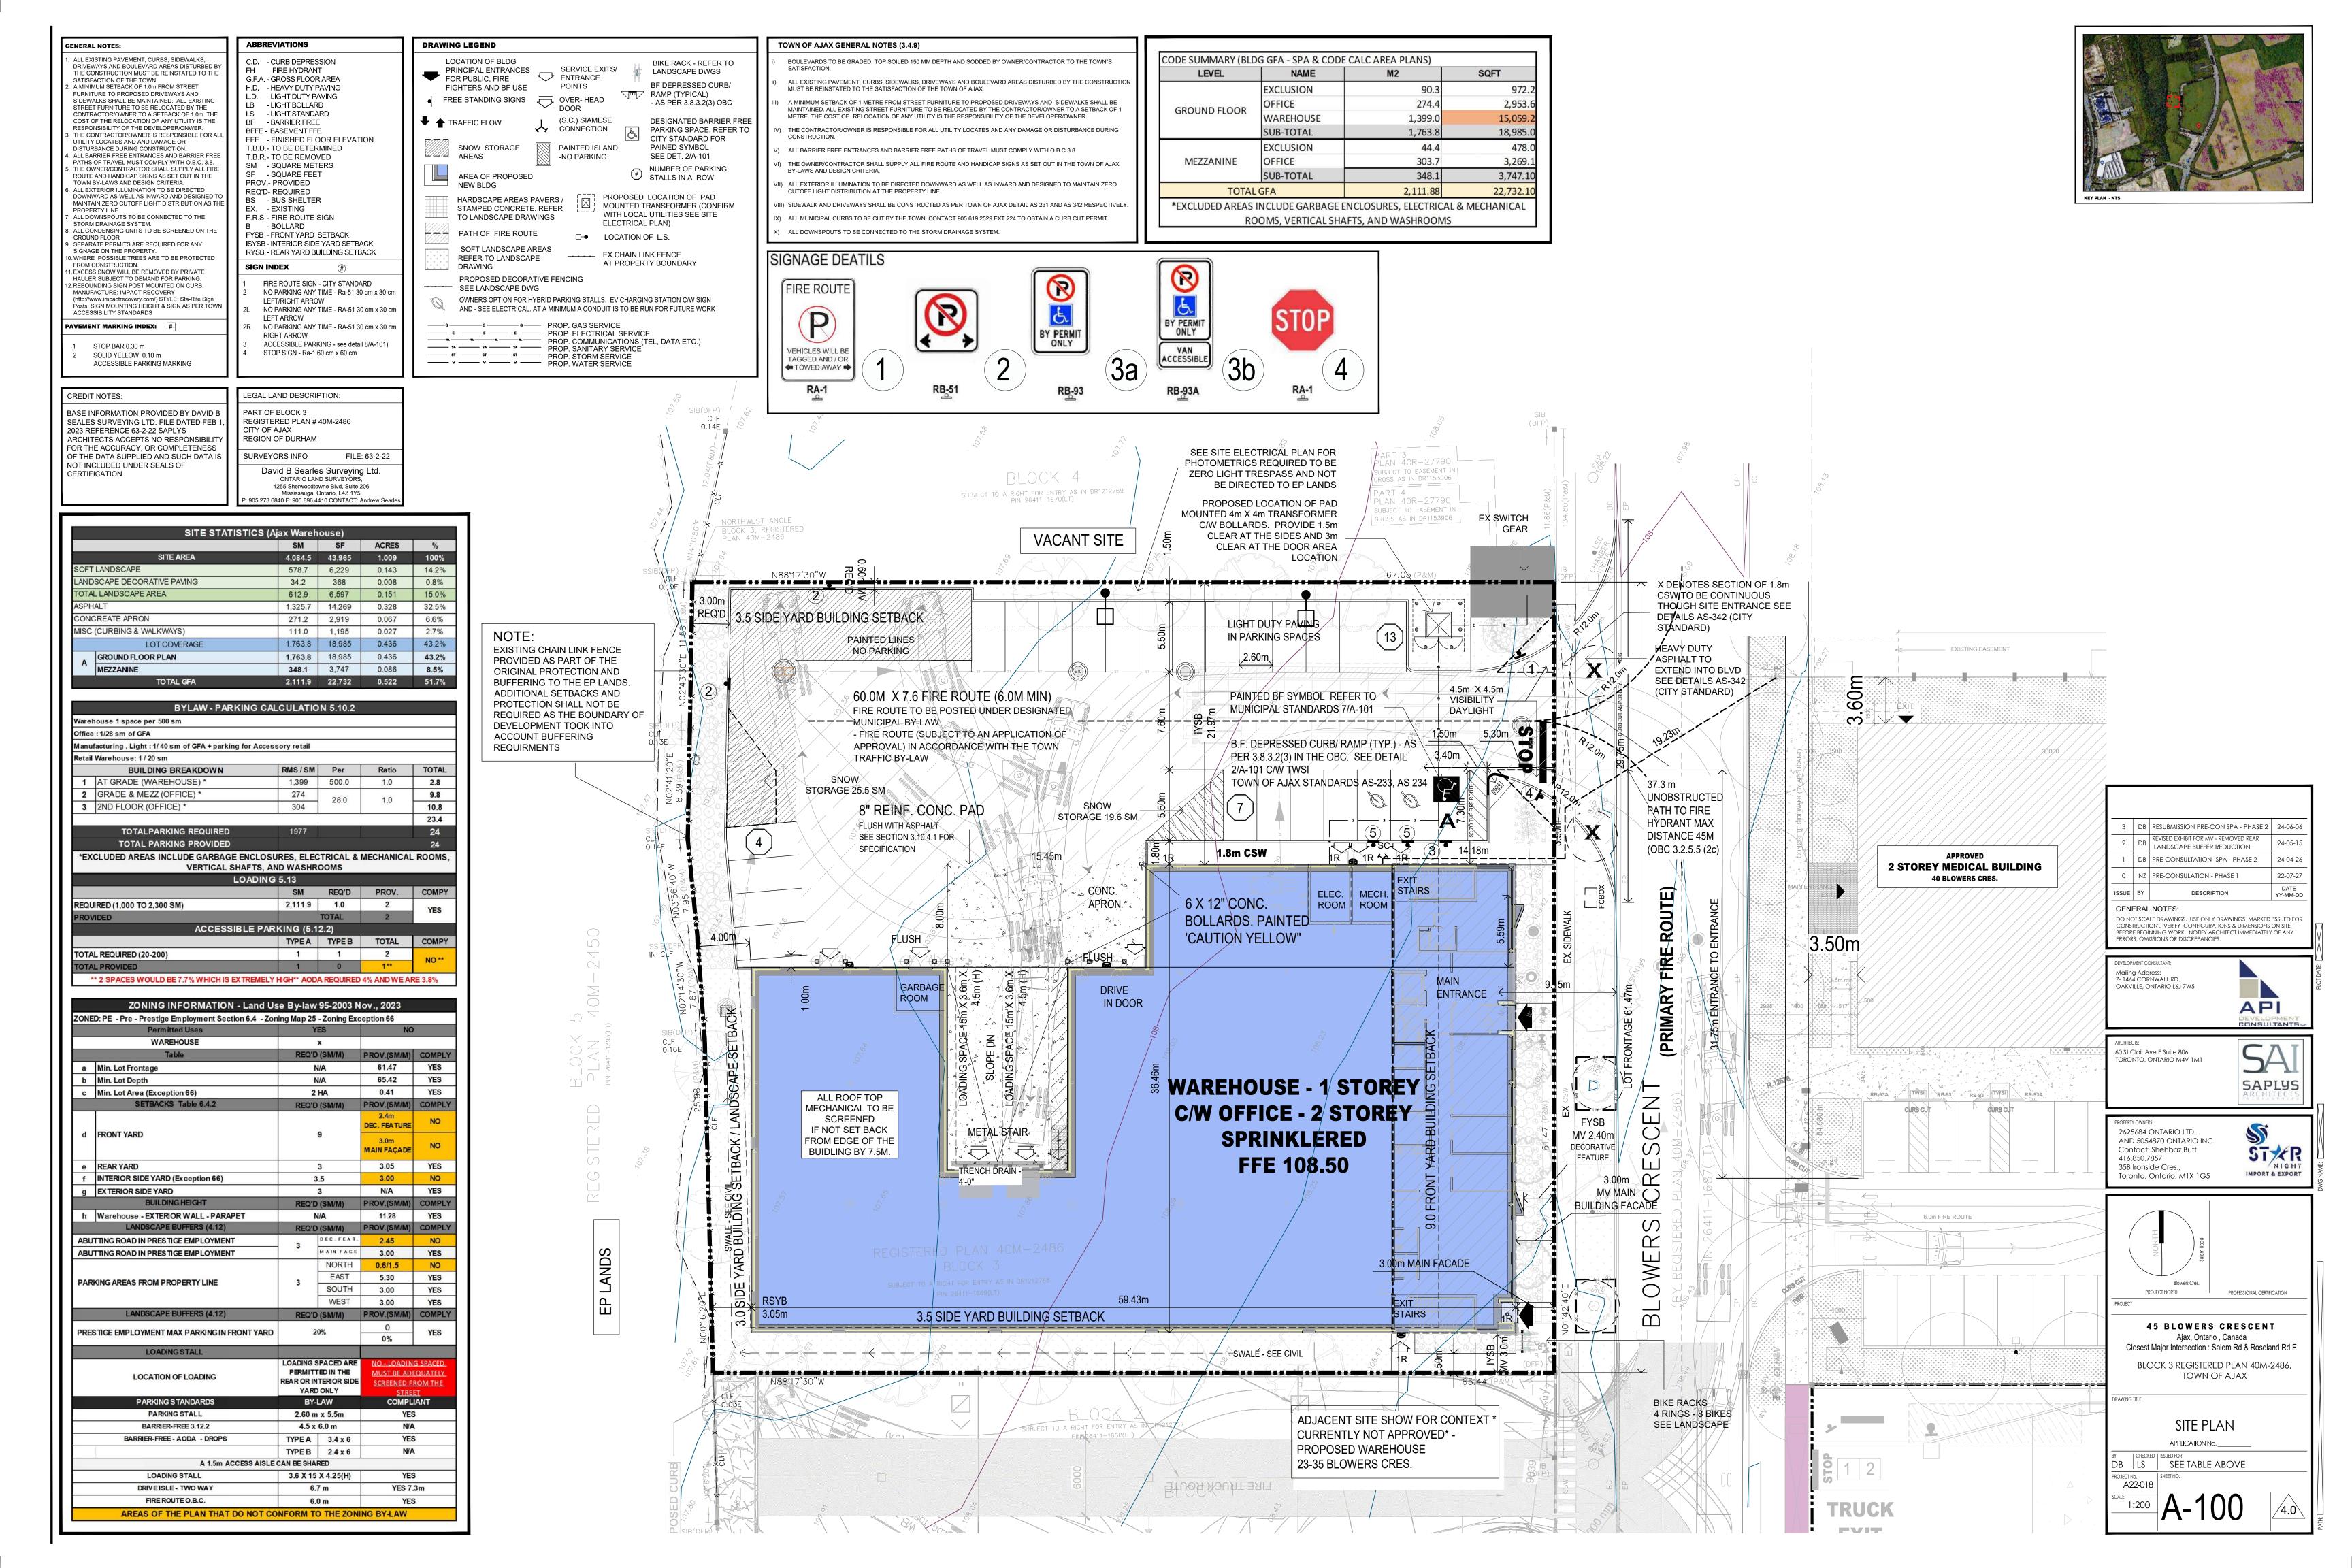

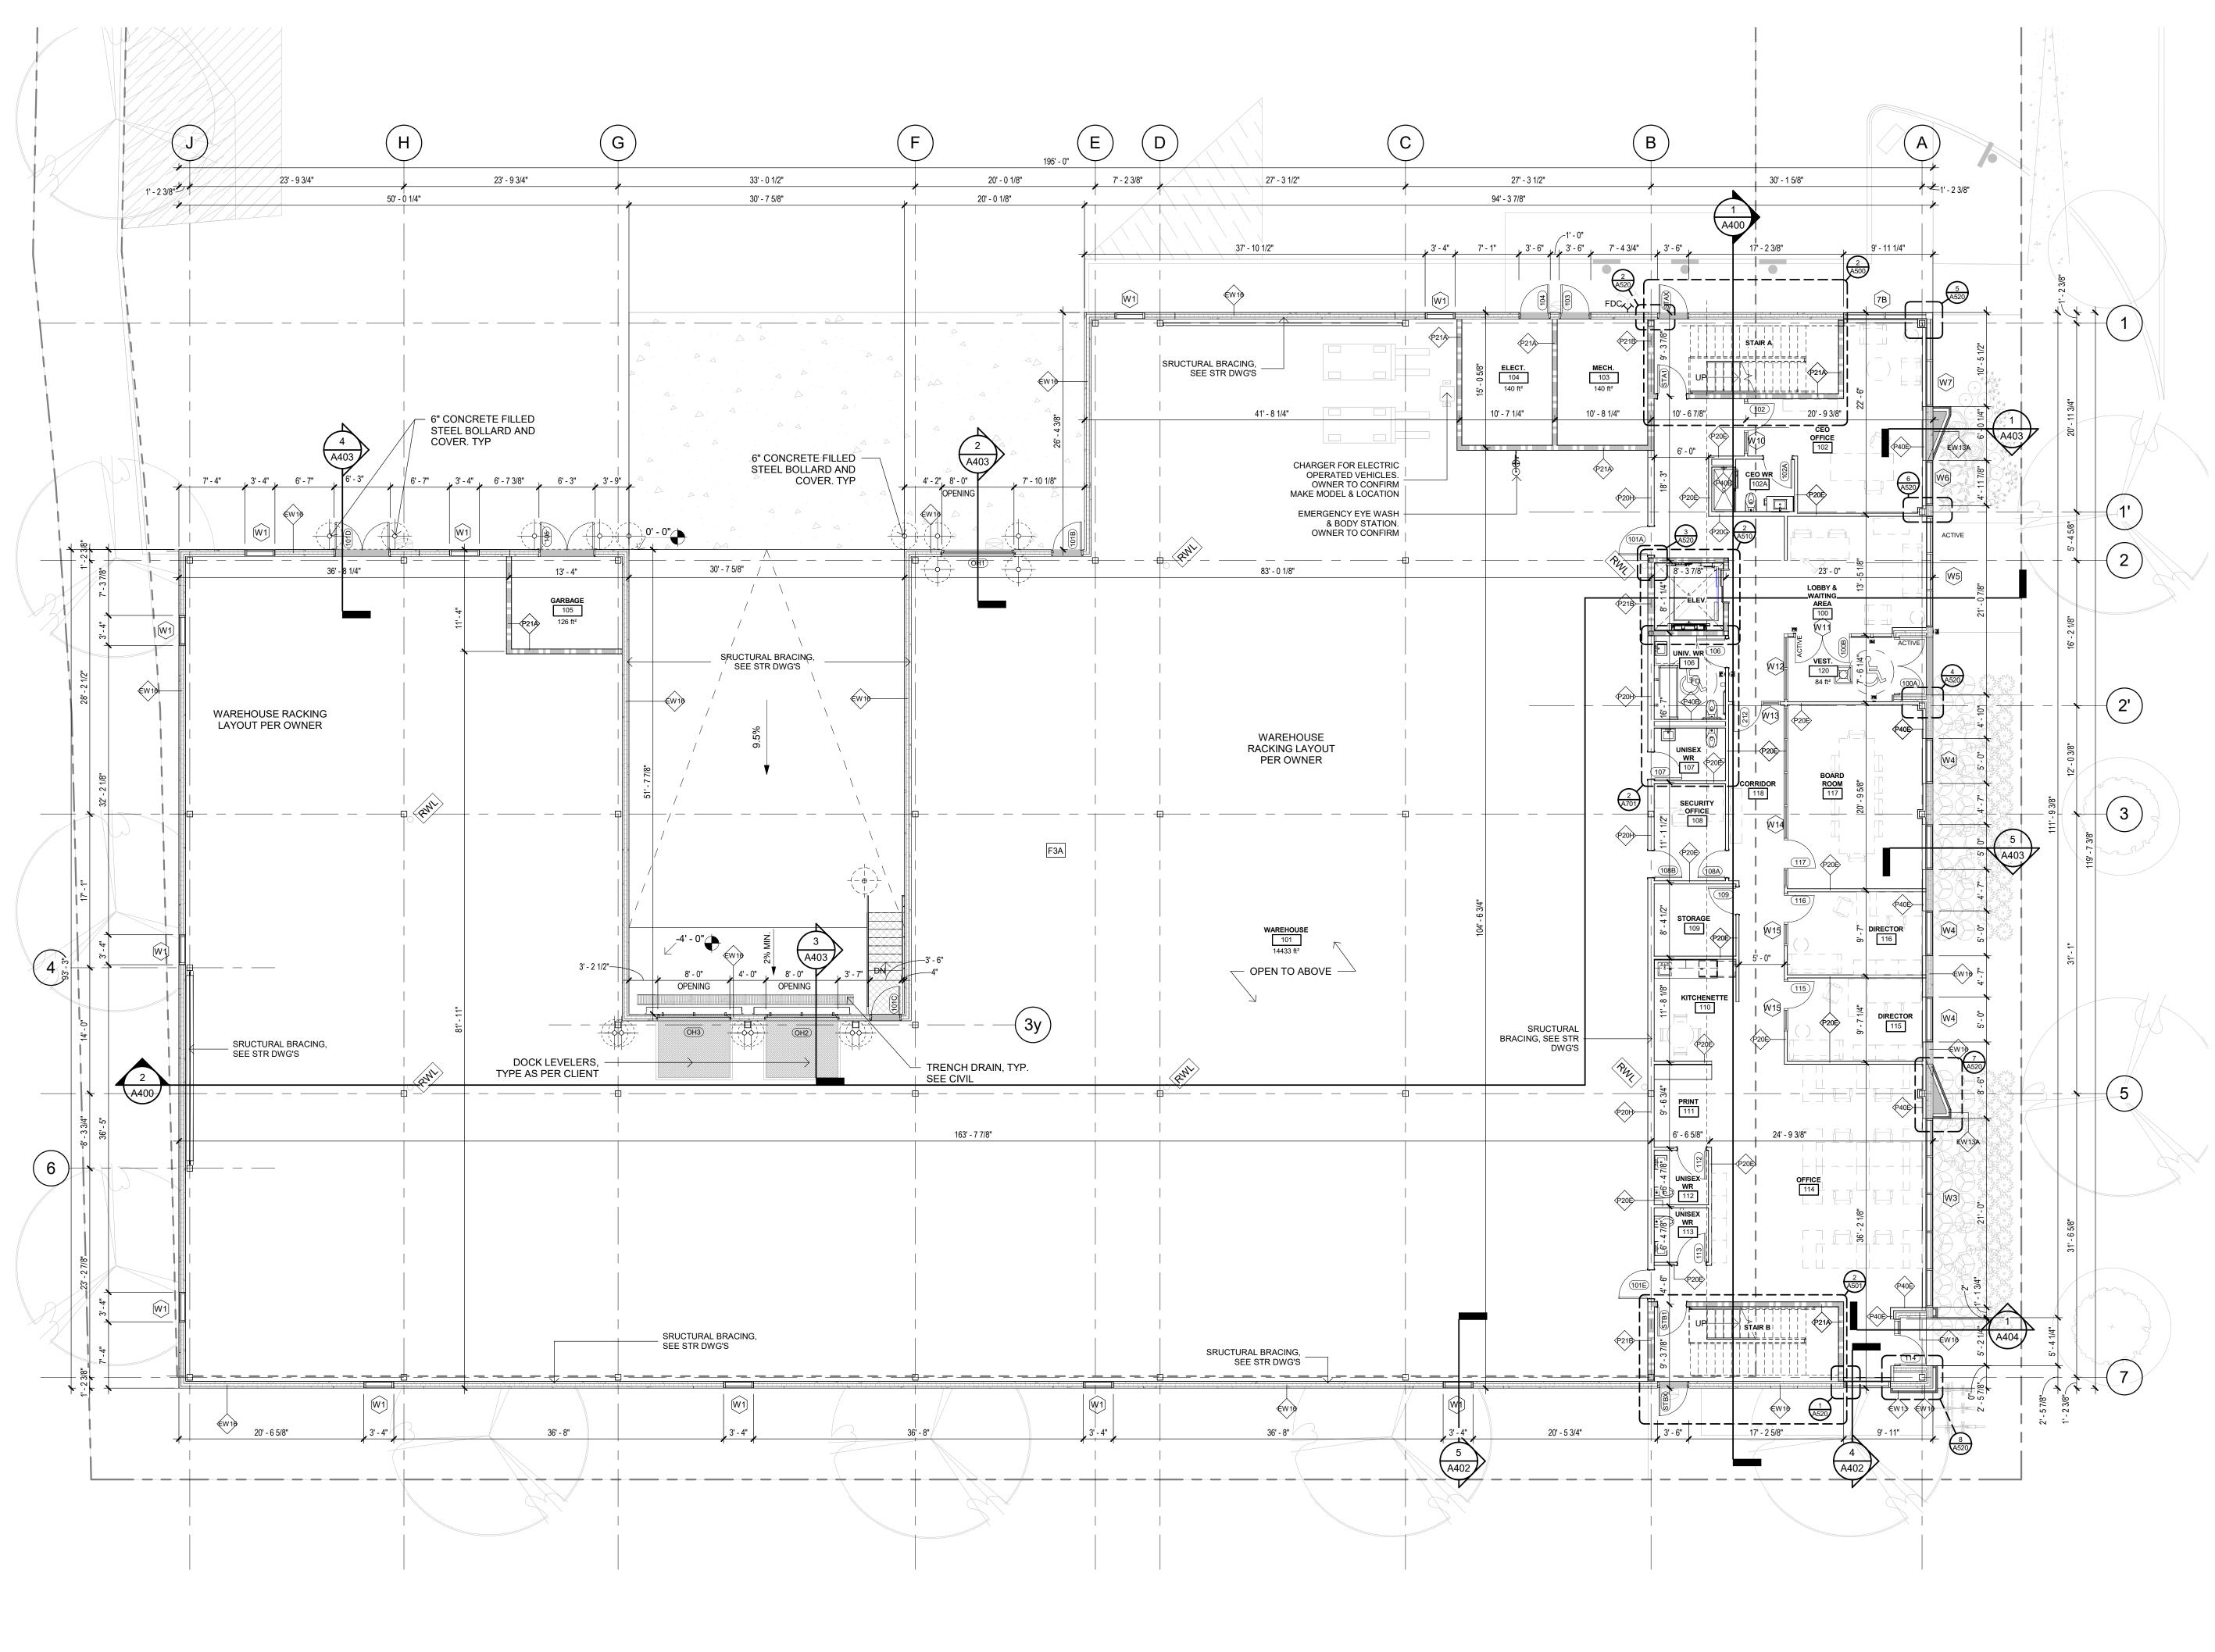

T/O GROUND FLOOR
A201 1: 100

<u>N</u>

THE ELEVATOR HOISTWAY DIMENSIONS SHOWN ARE FOR GENERAL INFORMATION PURPOSES ONLY. DIMENSIONS SHOWN DO NOT REPRESENT THE SIZE TO BE CONSTRUCTED UNTIL VERIFIED BY THE OWNER AND/OR CONSTRUCTOR. CONSTRUCTION IS TO BE REVIEWED & APPROVED ELEVATOR SHOP DRAWINGS. ANY RESULTING COSTS DUE TO CONSTRUCTION WITHOUT REVIEWED & APPROVED SHOP DRAWINGS SHALL BE THE RESPONSIBILITY OF THE OWNER AND/OR CONSTRUCTOR.

BASIS OF DESIGN MODEL: SCHINDLER 3100 MRL CAPACITY: 2500 LBS. OWNER TO

CONFIRM ELEVATOR AND SIZE

NOT ISSUED FOR CONSTRUCTION

 2
 NZ
 CLIENT REVIEW
 24-06-19

 1
 NZ
 CLIENT REVIEW
 24-07-10

 No.
 By
 Description
 Date YY-MM-DD

ISSUANCE SCHEDULE

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DEVELOPMENT CONSULTANT:

API CONSULTANTS INC. 1464 CORNWALL ROAD, UNIT 7 OAKVILLE, ONTARIO L6J 7W5

IT 7 API

ARCHITECT:

P: 905.337.7249

SAPLYS ARCHITECTS INC.

1464 CORNWALL ROAD, UNIT 8
OAKVILLE, ONTARIO L6J 7W5

CLIENT: STARNIGHT IMPORT & EXPORT

35B IRONSIDE CRESCENT SCARBOROUGH, ON M1X 1G5 ST R



WAREHOUSE & OFFICE HEADQUARTERS

45 BLOWERS CRES AJAX, ON L1Z 0N4


GROUND FLOOR PLAN


BY CHECK ISSUED FOR CLIENT REVIEW
PROJECT NO.: A22-018
SCALE:

As indicated

ISSUE DATE: **24-06-19**

A201 2 SHE

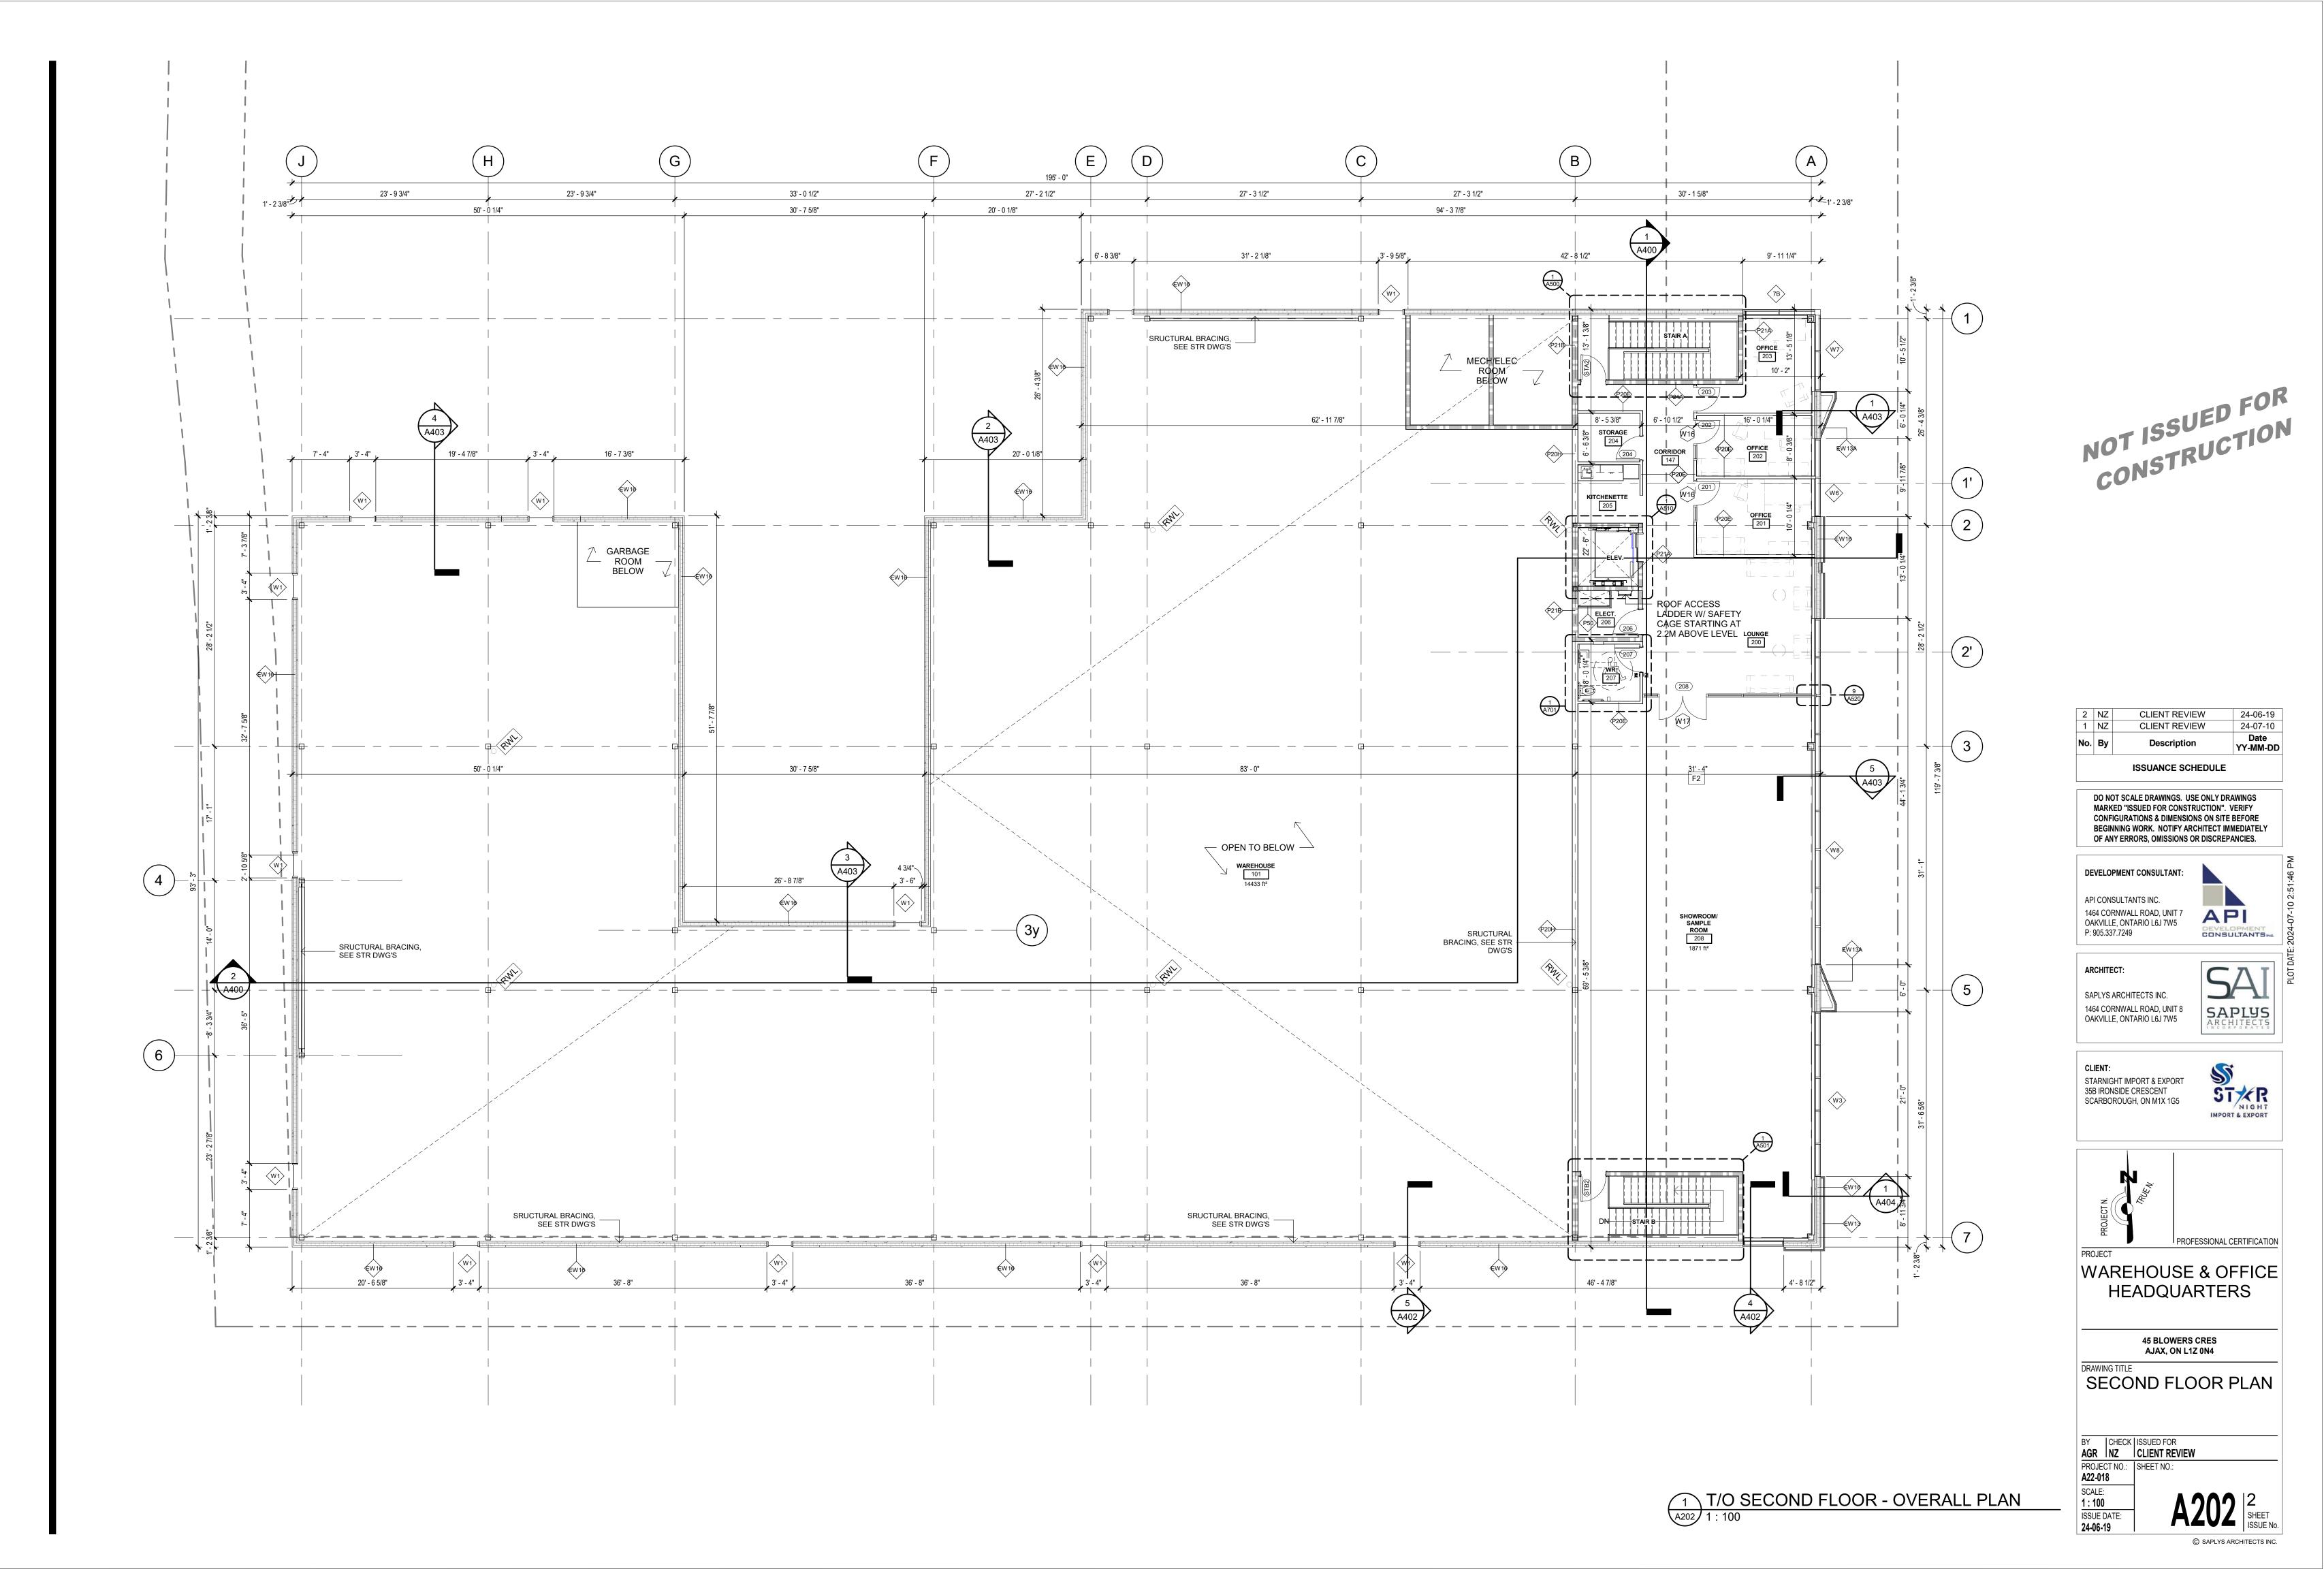

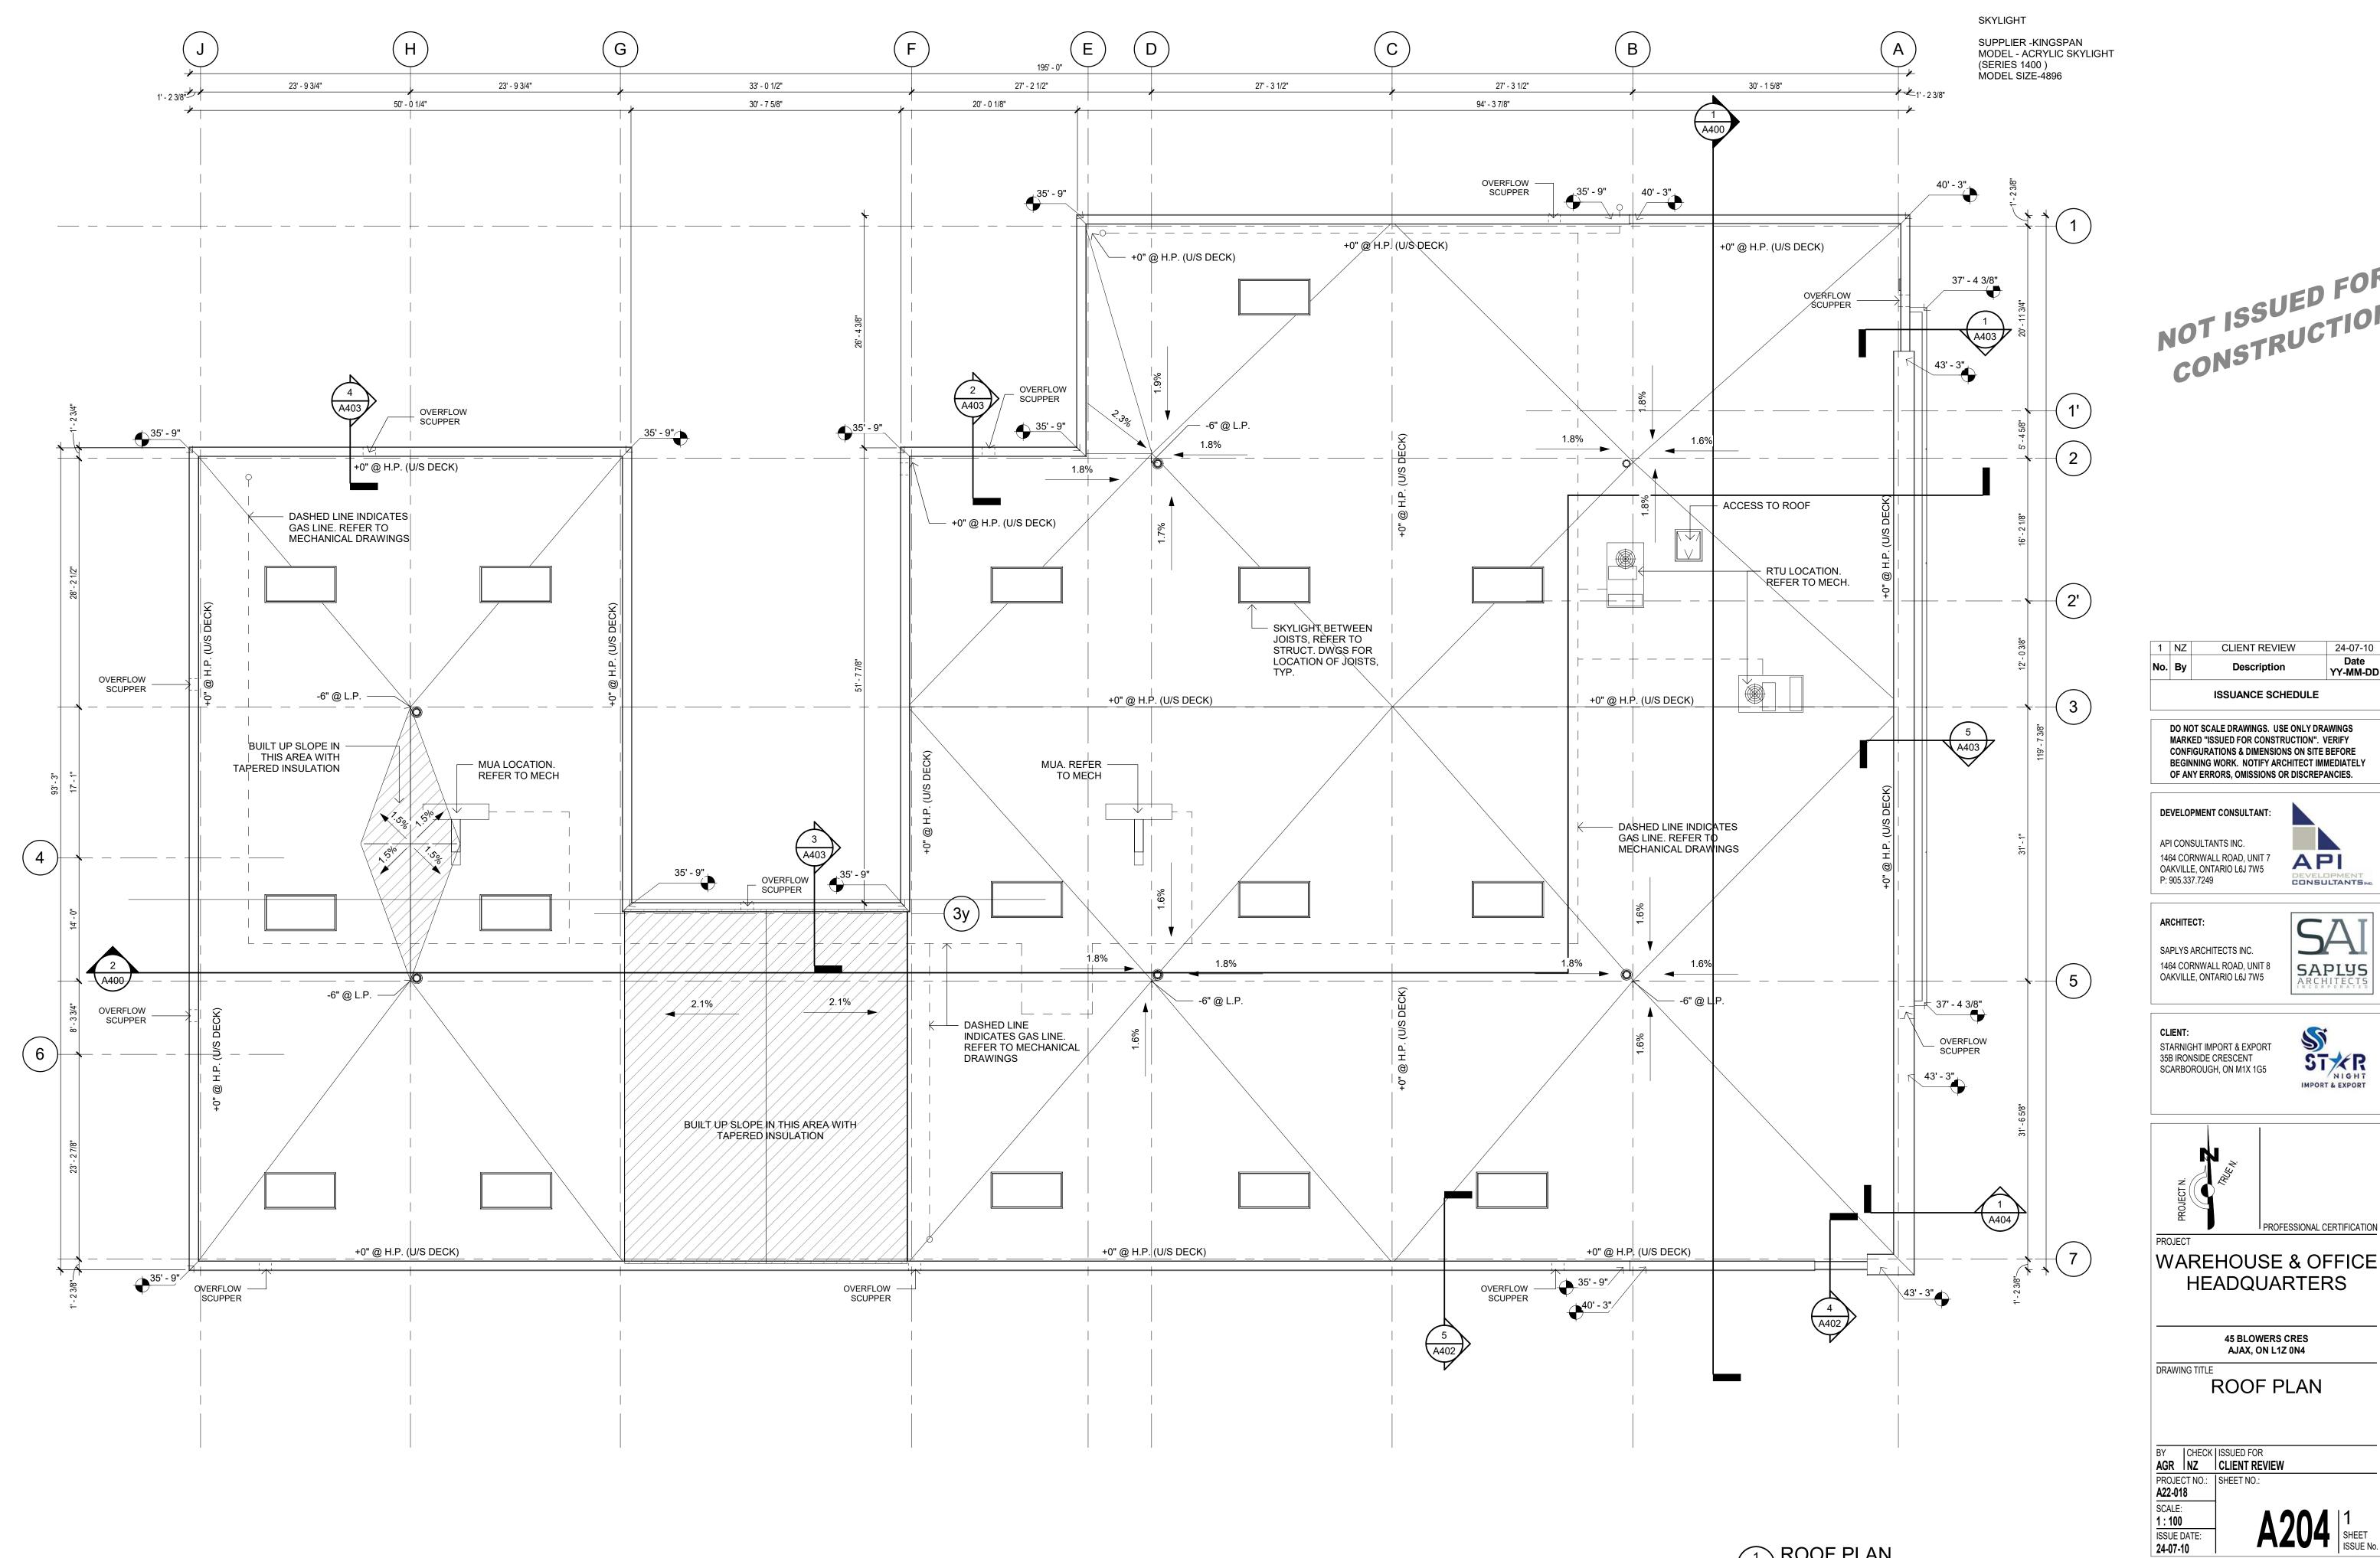



24-07-10 Date YY-MM-DD




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1 ROOF PLAN 1: 100



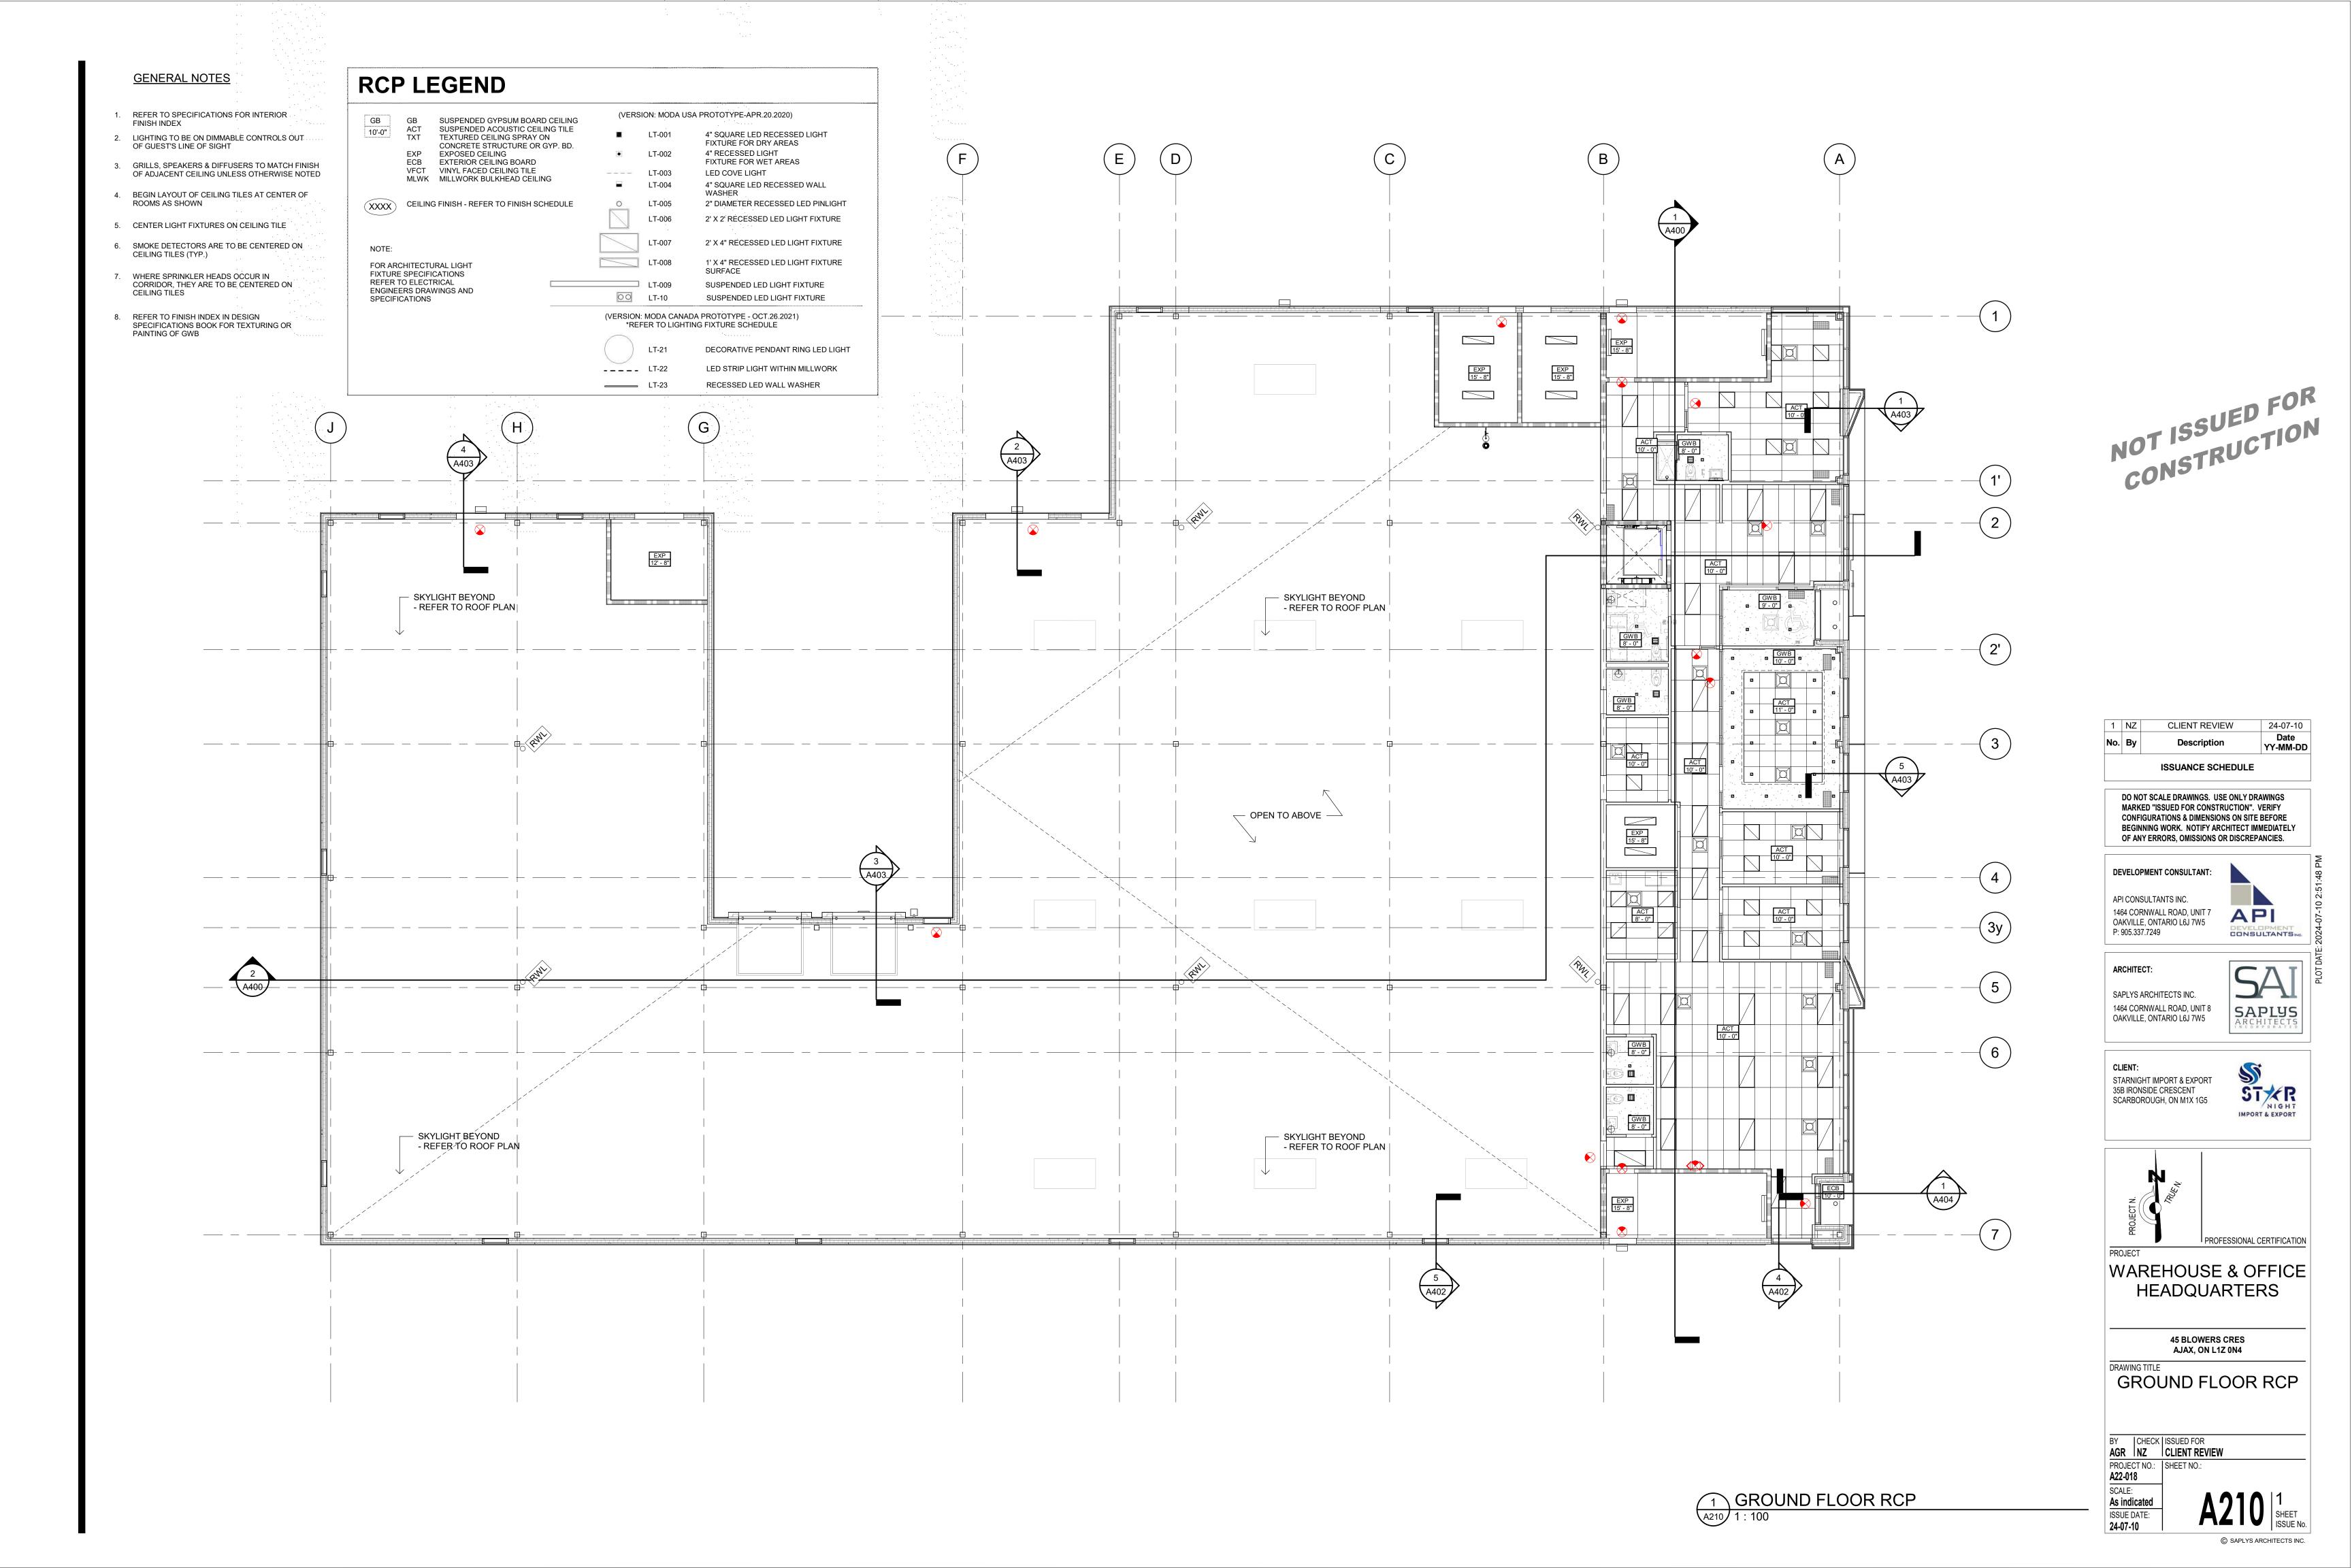

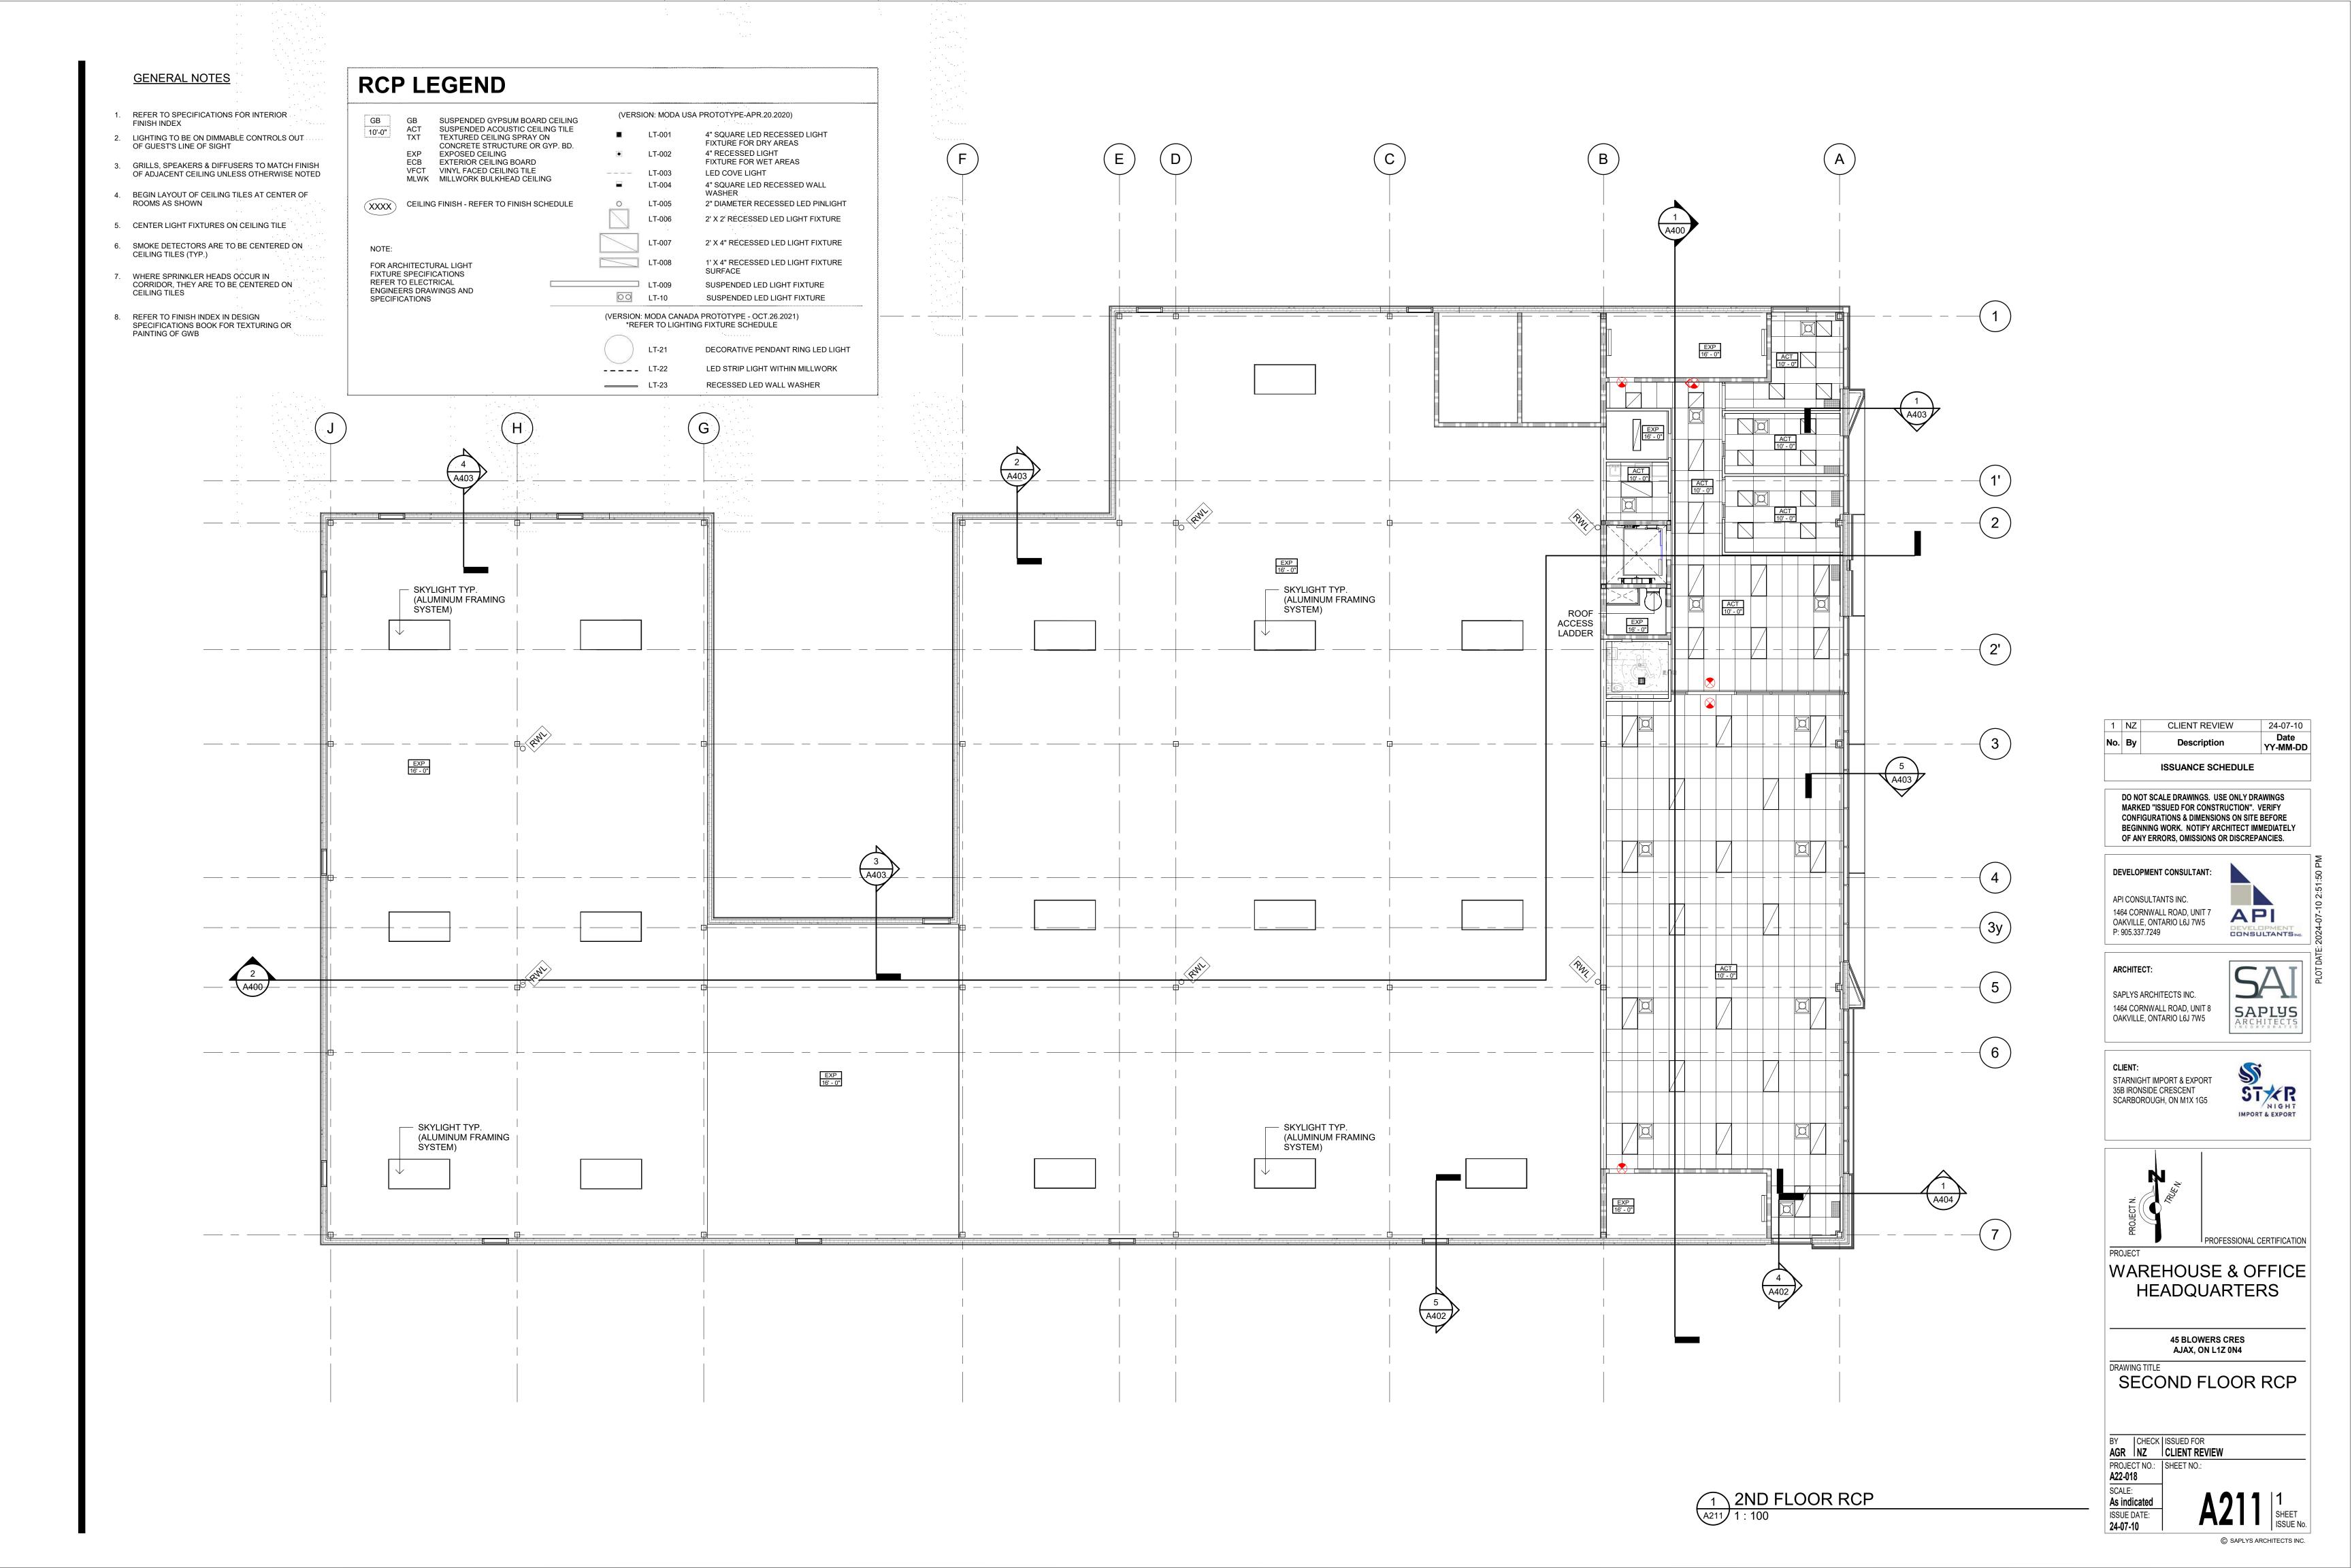

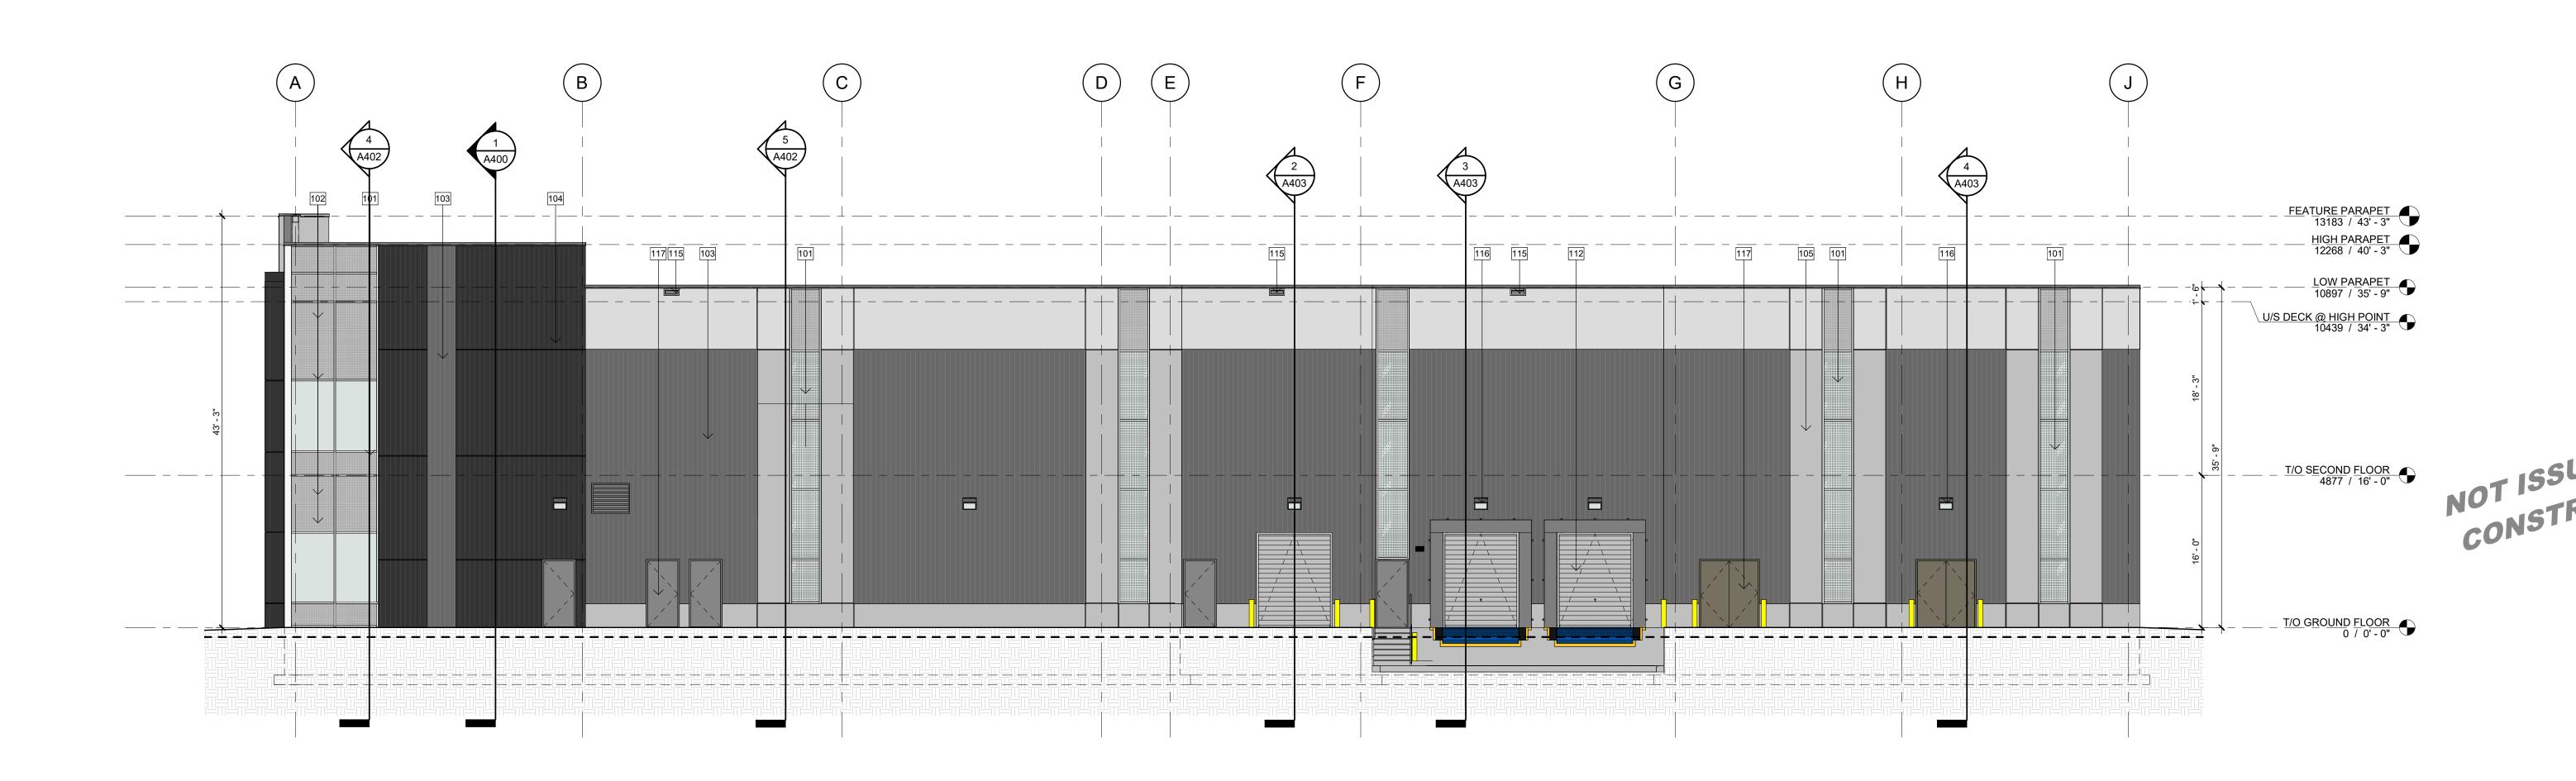






EXTERIOR ELEVATION LEGEND

- 101 GREY TINTED SEALED VISION GLASS UNITS IN PREFINISHED THERMALLY BROKEN ALUMINUM FRAMING. CLEAR ANODIZED EXTERIOR 19MM CAPS AS ILLUSTRATED.
- 102 GREY TINTED SEALED SPANDREL GLASS UNITS WITH INSULATED GALVANIZED METAL BACK PAN IN PREFINISHED THERMALLY BROKEN ALUMINUM FRAMING, MIN. R20. CLEAR ANODIZED EXTERIOR 19MM CAPS AS ILLUSTRATED.
- 103 INSULATED PRECAST CONCRETE SANDWICH PANELS, R-17 MINIMUM. 60MM VERTICAL RIBBED PROFILE. COLOUR: GRAY.
- 104 INSULATED PRECAST CONCRETE SANDWICH PANELS, R-17 MINIMUM. 60MM VERTICAL RIBBED PROFILE. COLOUR: DARK CHARCOAL.
- 105 INSULATED PRECAST CONCRETE SANDWICH PANELS, R-17 MINIMUM. 2.5"W x 1"D VERTICAL AND HORIZONTAL REVEALS AT ILLUSTRATED LOCATIONS. COLOUR: GRAY.
- MEDIUM SANDBLAST, SMOOTH BROOM FINISH. 106 INSULATED PRECAST CONCRETE SANDWICH PANELS, R-17 MINIMUM. 2.5"W x 1"D
- VERTICAL AND HORIZONTAL REVEALS AT ILLUSTRATED LOCATIONS. COLOUR: LIGHT GRAY. MEDIUM SANDBLAST, SMOOTH BROOM FINISH. 107 PREFINISHED ALUMINUM COMPOSITE PANELS, R-25 MINIMUM. VENTED DRY JOINT CONSTRUCTION. COLOUR: DARK GRAY. VERTICAL/HORIZONTAL JOINTS AS
- 108 PREFINISHED ALUMINUM COMPOSITE PANELS, R-25 MINIMUM. VENTED DRY JOINT CONSTRUCTION. COLOUR: DEEP RED. VERTICAL/HORIZONTAL JOINTS AS ILLUSTRATED.
- 109 PREFINISHED ALUMINUM COMPOSITE PANELS, R-25 MINIMUM. VENTED DRY JOINT CONSTRUCTION. COLOUR: WHITE. VERTICAL/HORIZONTAL JOINTS AS ILLUSTRATED.
- 110 EXTERIOR ALUMINUM DOOR WITH CLEAR TEMPERED VISION GLASS UNITS IN PREFINISHED THERMALLY BROKEN ALUMINUM ENTRANCE FRAMING.
- 112 OVERHEAD SECTIONAL STEEL DRIVE-IN DOOR WITH VISION PANELS, 8'W x 10'H, ELECTRICALLY OPERATED. INSULATED & PREFINISHED COMPLETE WITH DOCK LEVELER, DOCK SEALS & BUMPERS.
- 115 OVERFLOW ROOF SCUPPER (6"H x 12"W CLEAR OPENING).
- 116 EXTERIOR LIGHTING FIXTURE. REFER TO ELECTRICAL DRAWINGS.
- 117 EXTERIOR INSULATED METAL DOOR. REFER TO DOOR SCHEDULE.

BIR	D FRIENDLY DESIGN TABLE						
ELEVATION	GLAZING						
ELEVATION	AREA m2	TREATED m2	%				
NORTH	66.8	60	90%				
EAST	133.3	113.3	85%				
SOUTH	47.8	47.8	100%				
WEST	20.3	20.3	100%				
TOTAL	268.2	241.4	90%				



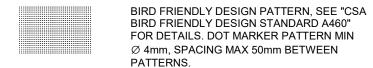

OF ANY ERRORS, OMISSIONS (OR DISCREPANCIES.
DEVELOPMENT CONSULTANT:	
API CONSULTANTS INC. 1464 CORNWALL ROAD, UNIT 7 OAKVILLE, ONTARIO L6J 7W5	API
P: 905.337.7249	CONSULTANTS
ARCHITECT:	CVI
SAPLYS ARCHITECTS INC.	

CLIENT REVIEW

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24-07-10 Date YY-MM-DD







CLIENT:


WAREHOUSE & OFFICE **HEADQUARTERS**


> 45 BLOWERS CRES AJAX, ON L1Z 0N4

EXTERIOR ELEVATION I

BY CHECK ISSUED FOR AGR NZ CLIENT REVIEW PROJECT NO.: | SHEET NO.: A22-018 SCALE: As indicated

ISSUE DATE:

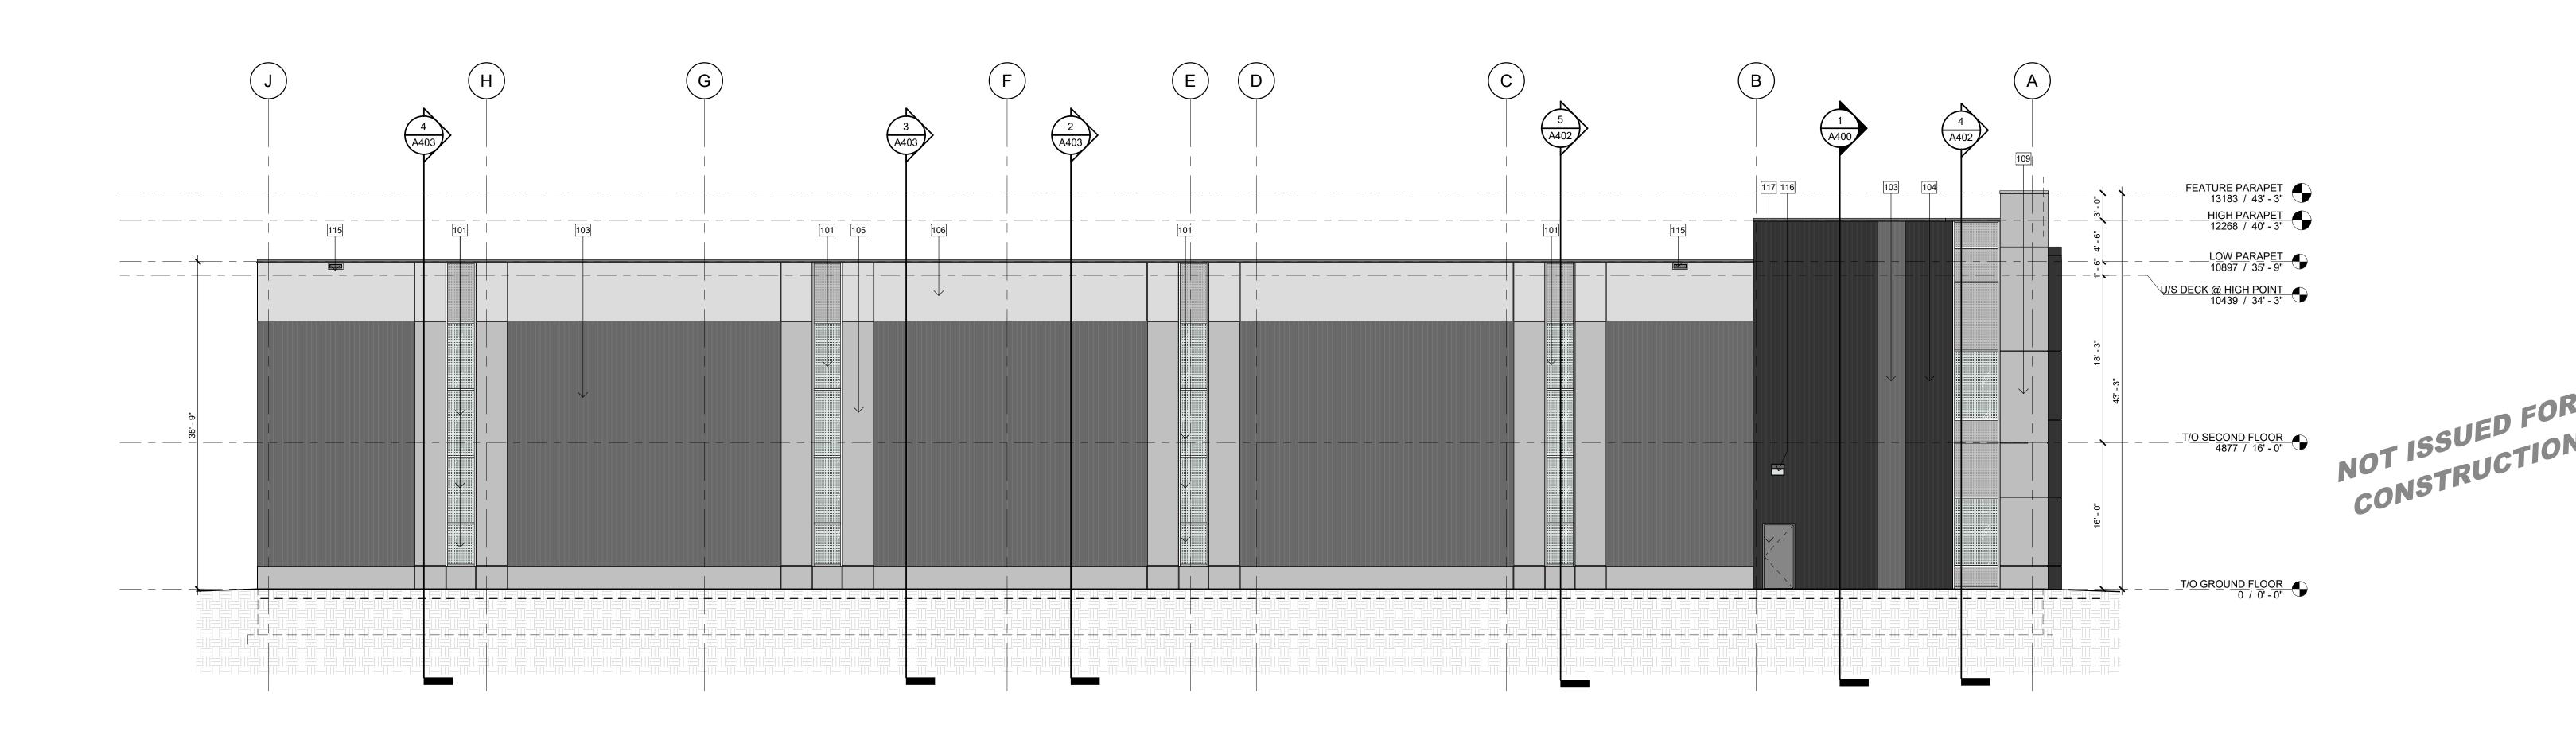

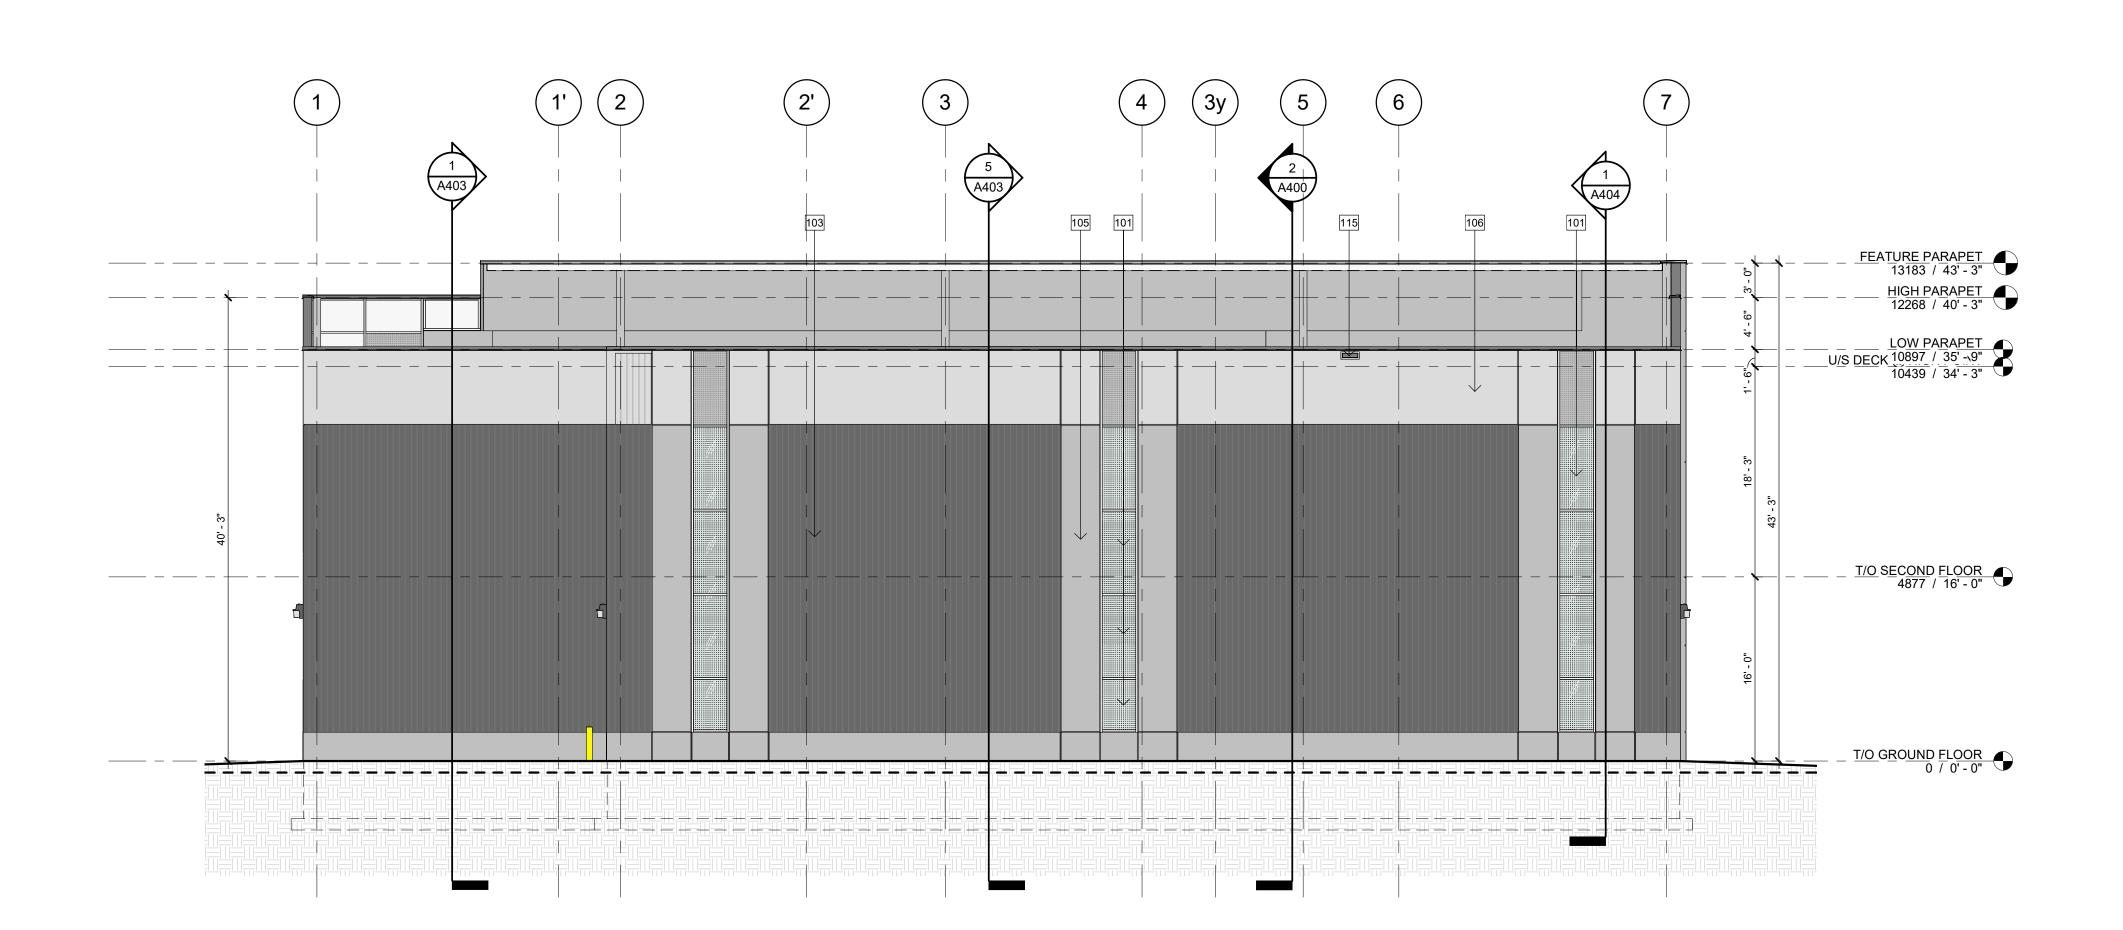





EXTERIOR ELEVATION LEGEND

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- CONSTRUCTION. COLOUR: WHITE. VERTICAL/HORIZONTAL JOINTS AS ILLUSTRATED. 110 EXTERIOR ALUMINUM DOOR WITH CLEAR TEMPERED VISION GLASS UNITS IN
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PREFINISHED THERMALLY BROKEN ALUMINUM ENTRANCE FRAMING.


115 OVERFLOW ROOF SCUPPER (6"H x 12"W CLEAR OPENING).

LEVELER, DOCK SEALS & BUMPERS.


- 116 EXTERIOR LIGHTING FIXTURE. REFER TO ELECTRICAL DRAWINGS.
- 117 EXTERIOR INSULATED METAL DOOR. REFER TO DOOR SCHEDULE.

GLAZING TREATED m2	0/
1	0/
TREATED m2	0/
	%
60	90%
113.3	85%
47.8	100%
20.3	100%
241.4	90%
	60 113.3 47.8 20.3

SYMBOL LEGEND

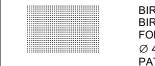

BIRD FRIENDLY DESIGN PATTERN, SEE "CSA BIRD FRIENDLY DESIGN STANDARD A460" FOR DETAILS. DOT MARKER PATTERN MIN Ø 4mm, SPACING MAX 50mm BETWEEN PATTERNS.

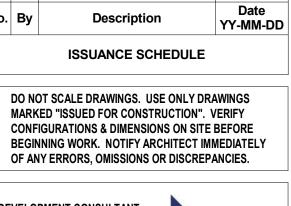

CLIENT REVIEW

24-07-10

DEVELOPMENT CONSULTANT: API CONSULTANTS INC.

ARCHITECT:

CLIENT:

API 1464 CORNWALL ROAD, UNIT 7 OAKVILLE, ONTARIO L6J 7W5 P: 905.337.7249 CONSULTANTSING

SAPLYS ARCHITECTS INC. 1464 CORNWALL ROAD, UNIT 8 OAKVILLE, ONTARIO L6J 7W5

STARNIGHT IMPORT & EXPORT 35B IRONSIDE CRESCENT SCARBOROUGH, ON M1X 1G5



PROFESSIONAL CERTIFICATION

WAREHOUSE & OFFICE **HEADQUARTERS**

45 BLOWERS CRES AJAX, ON L1Z 0N4 **EXTERIOR ELEVATION**

BY CHECK ISSUED FOR AGR NZ CLIENT REVIEW PROJECT NO.: SHEET NO.: A22-018 SCALE:

As indicated ISSUE DATE:



No.	Ву	Description	Date
1	NZ	CLIENT REVIEW	24-07-10
2	NZ	CLIENT REVIEW	24-06-19

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DEVELOPMENT CONSULTANT:

API CONSULTANTS INC. 1464 CORNWALL ROAD, UNIT 7 OAKVILLE, ONTARIO L6J 7W5 P: 905.337.7249

API

ARCHITECT:

SAPLYS ARCHITECTS INC. 1464 CORNWALL ROAD, UNIT 8 OAKVILLE, ONTARIO L6J 7W5

STARNIGHT IMPORT & EXPORT 35B IRONSIDE CRESCENT SCARBOROUGH, ON M1X 1G5






PROFESSIONAL CERTIFICATION


WAREHOUSE & OFFICE HEADQUARTERS

45 BLOWERS CRES AJAX, ON L1Z 0N4

ARTISTIC RENDER

BY CHECK ISSUED FOR CLIENT REVIEW
PROJECT NO.:
A22-018
SCALE:
1:21
ISSUE DATE:
24-06-19

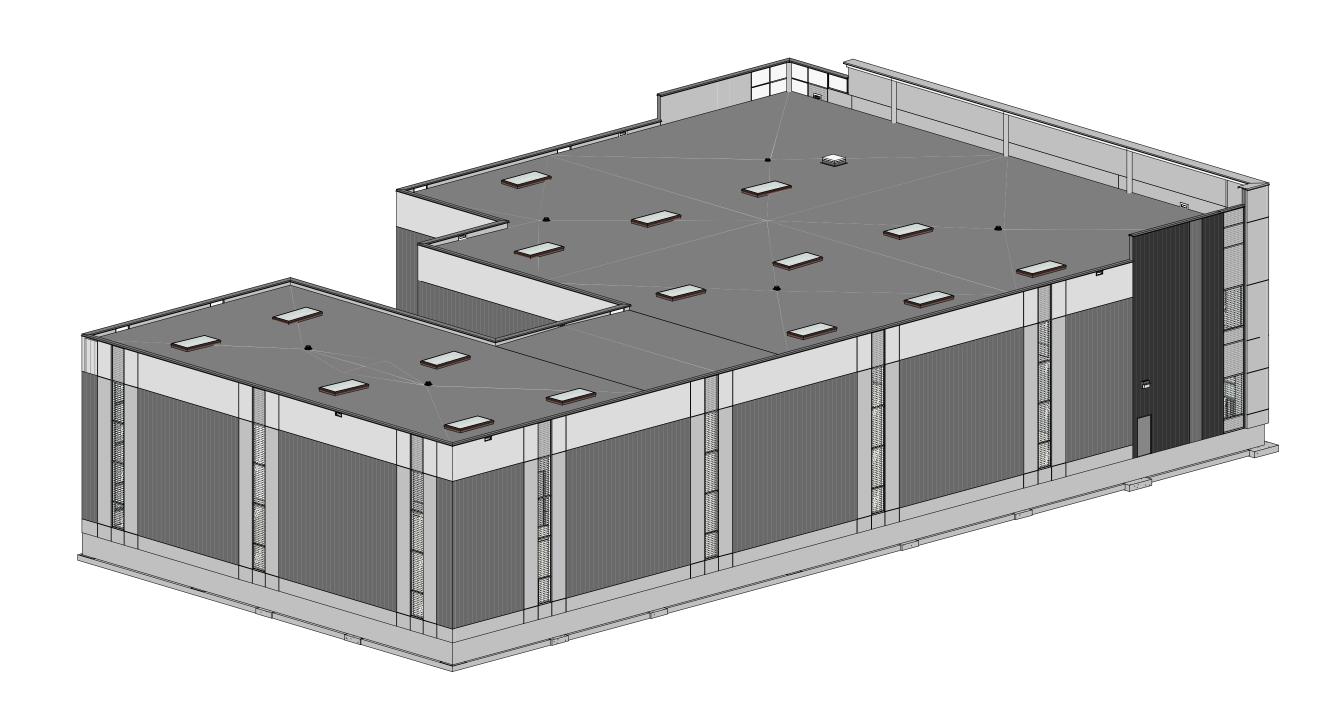

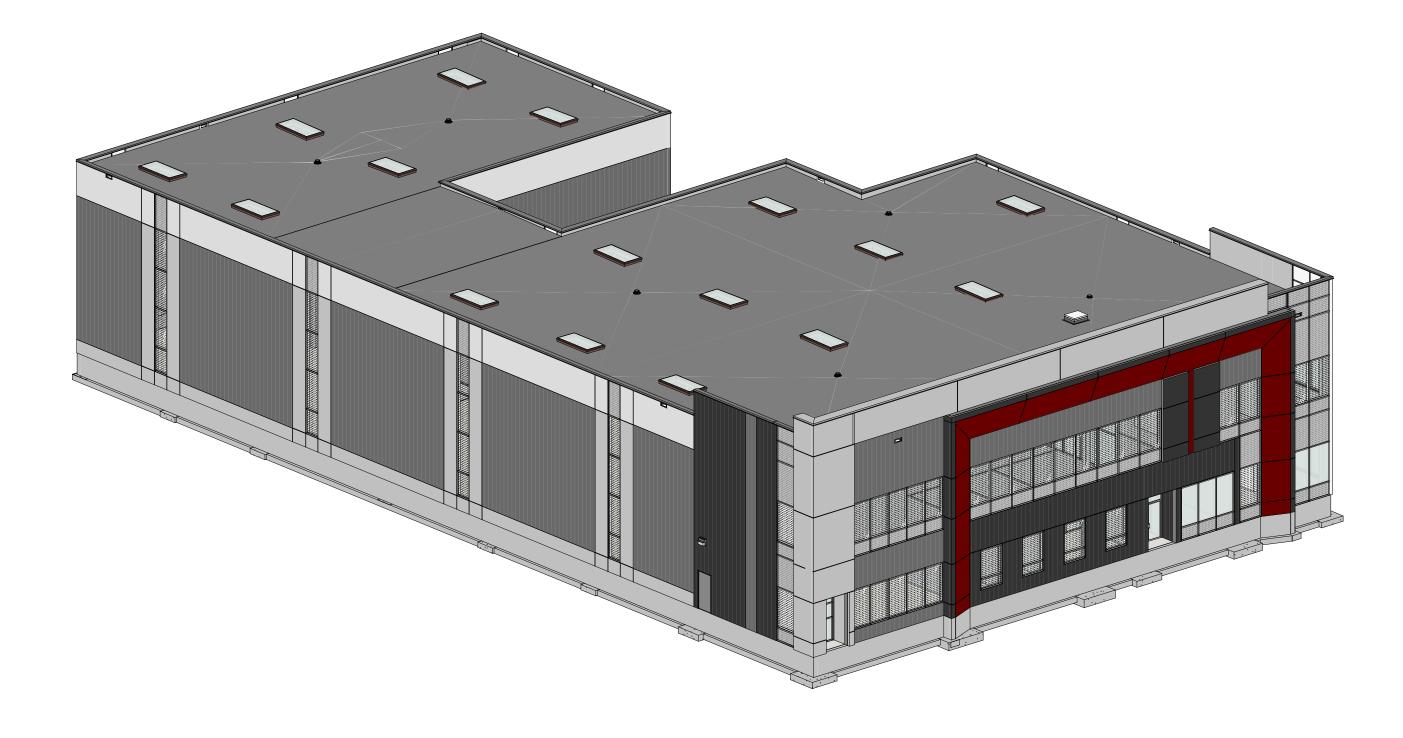

NOT ISSUED FOR CONSTRUCTION

CLIENT REVIEW

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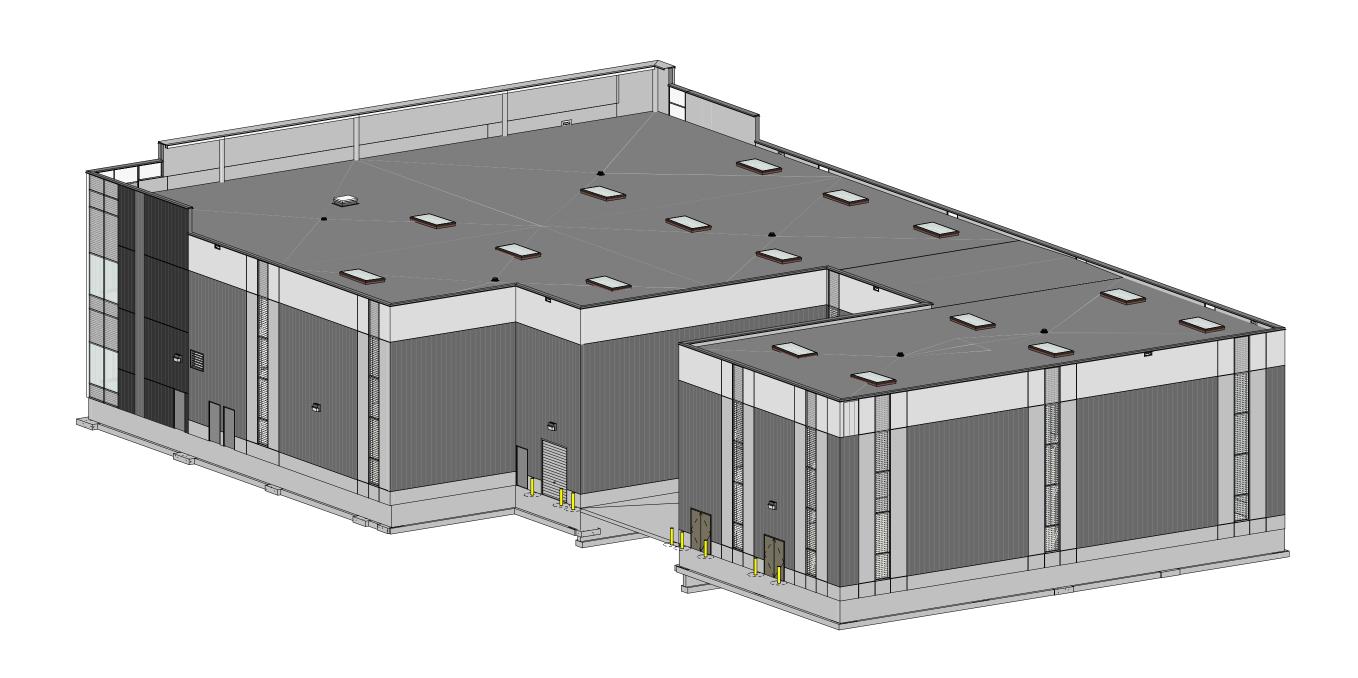
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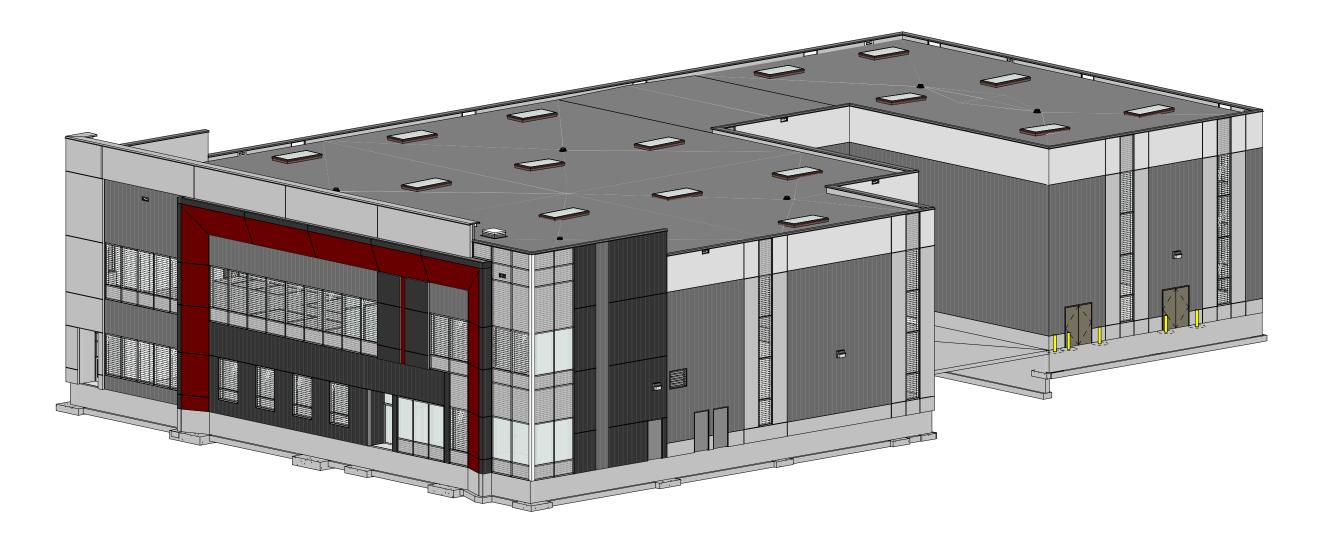
CONFIGURATIONS & DIMENSIONS ON SITE BEFORE BEGINNING WORK. NOTIFY ARCHITECT IMMEDIATELY OF ANY ERRORS, OMISSIONS OR DISCREPANCIES.

1 SOUTHWEST VIEW

4 NORTHWEST VIEW


2 SOUTHEAST VIEW FROM BLOWERS CRES







3 NORTHEAST VIEW FROM BLOWERS CRES




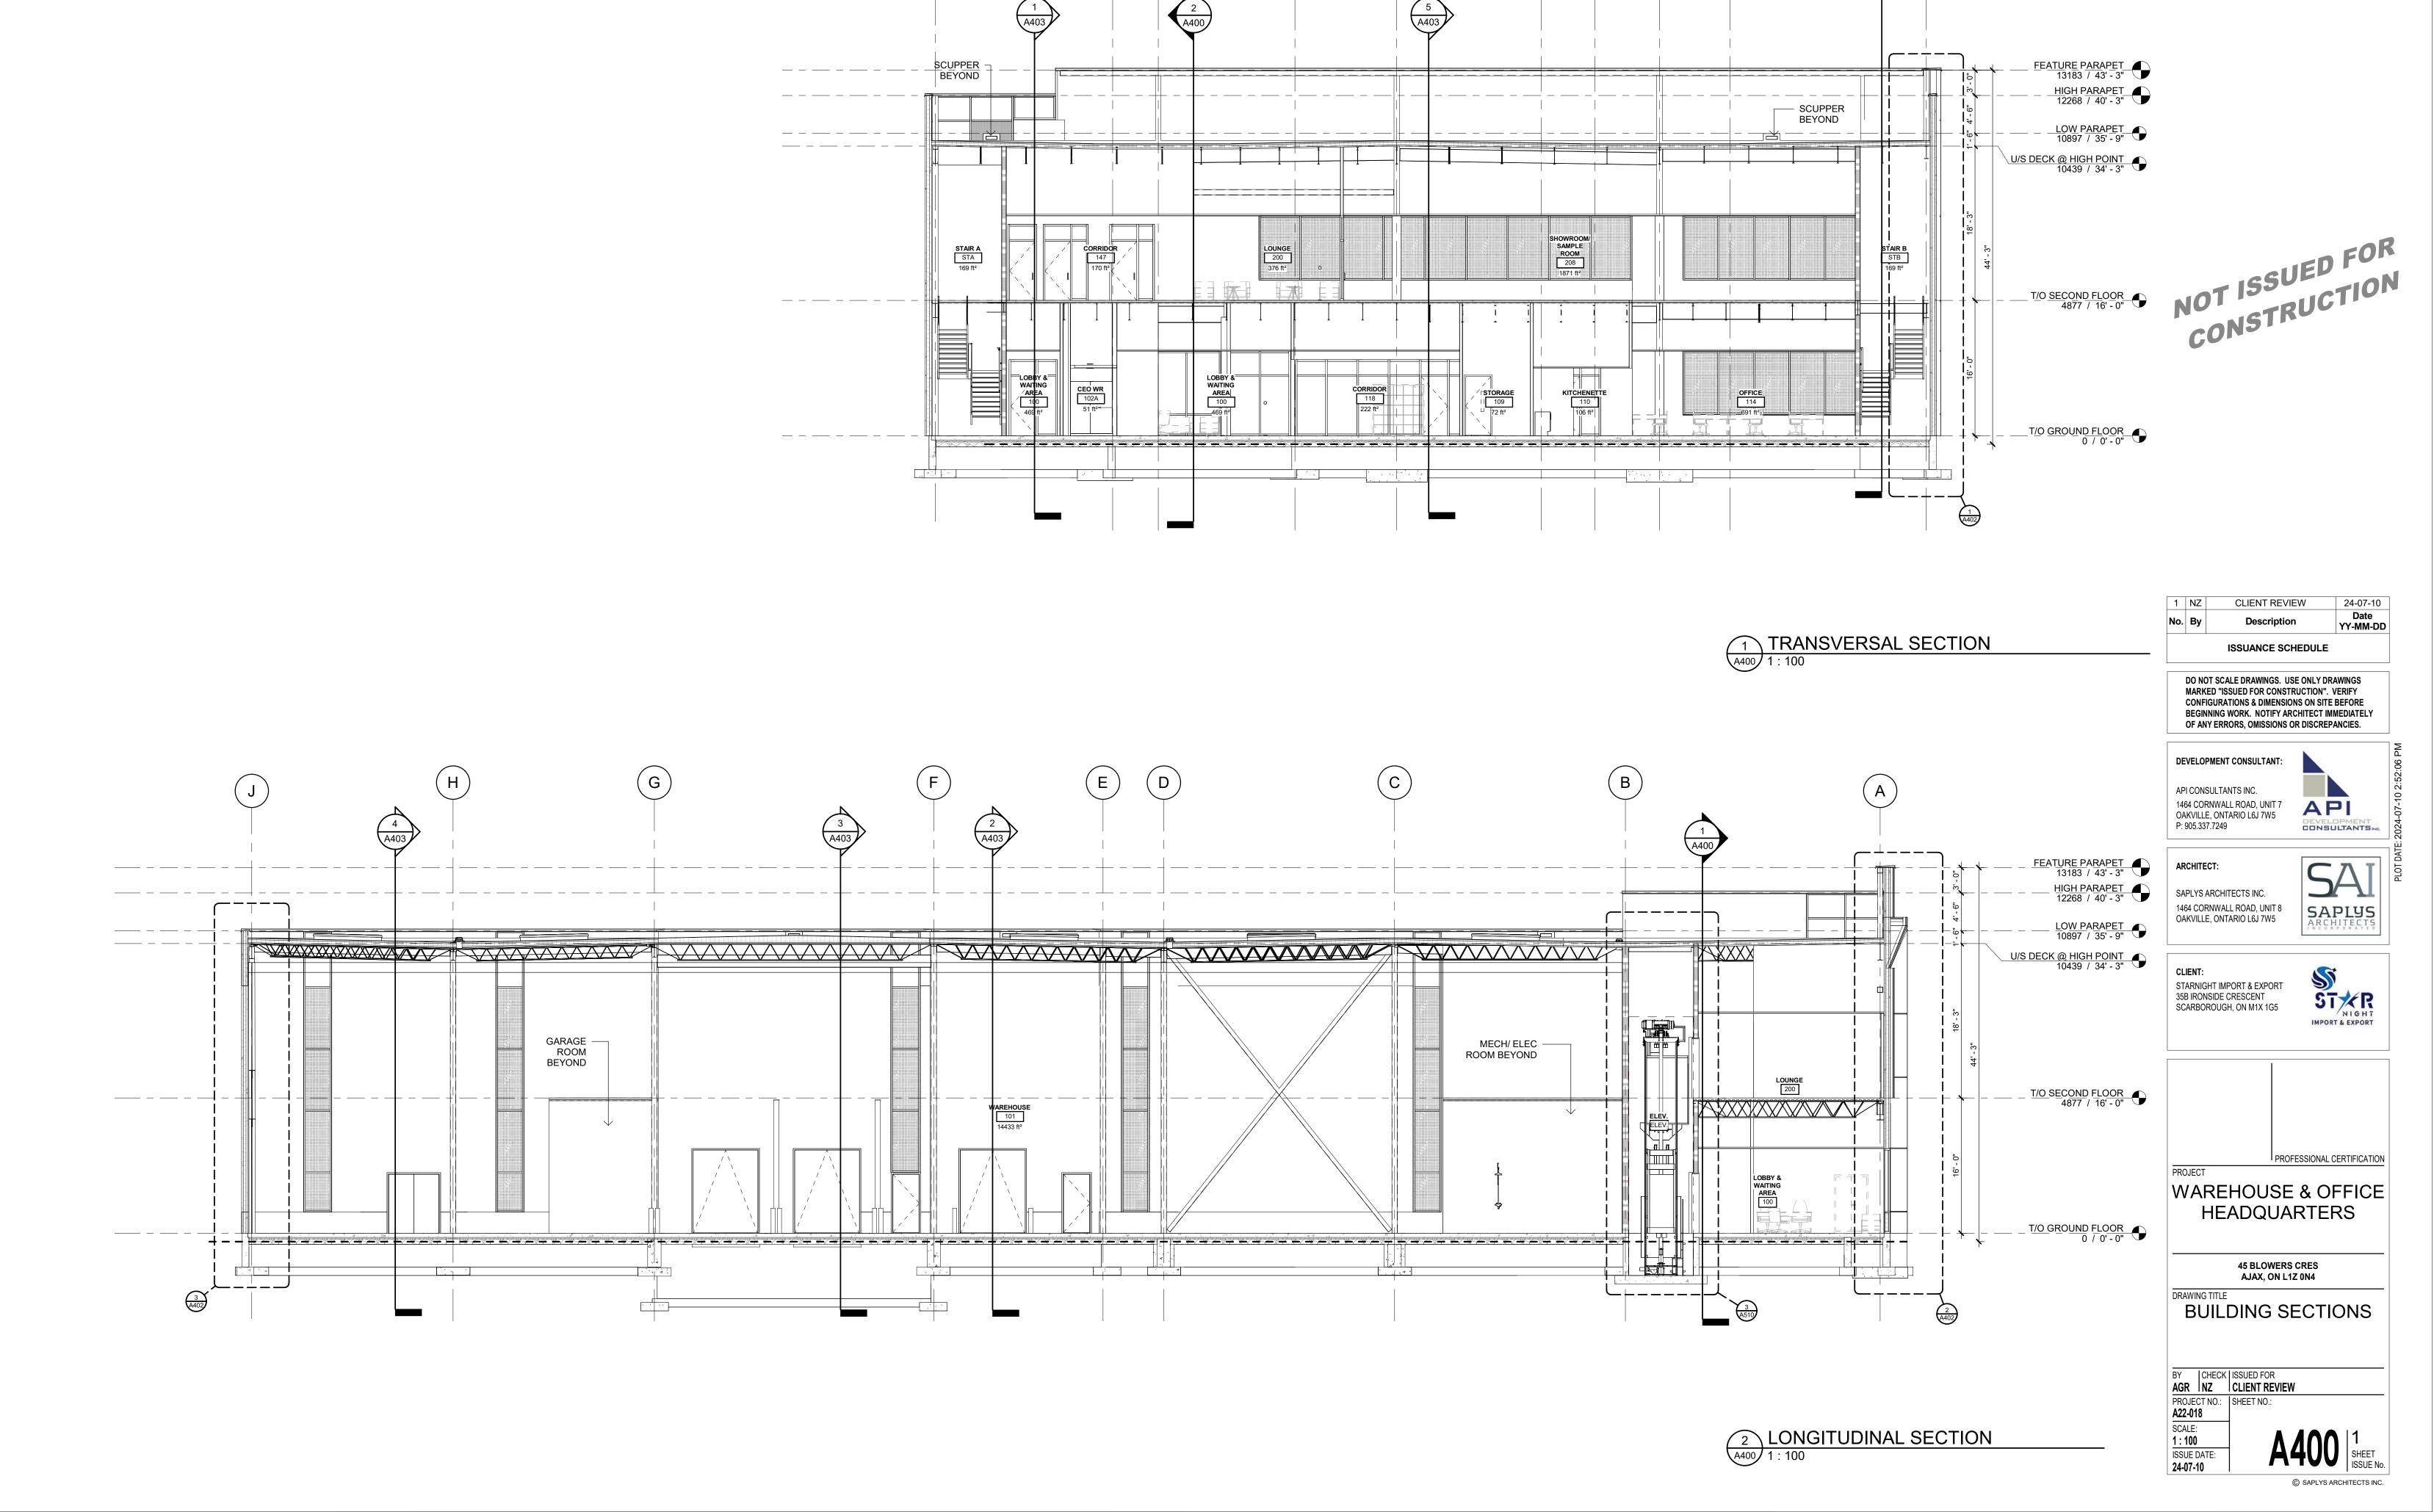


(3y)

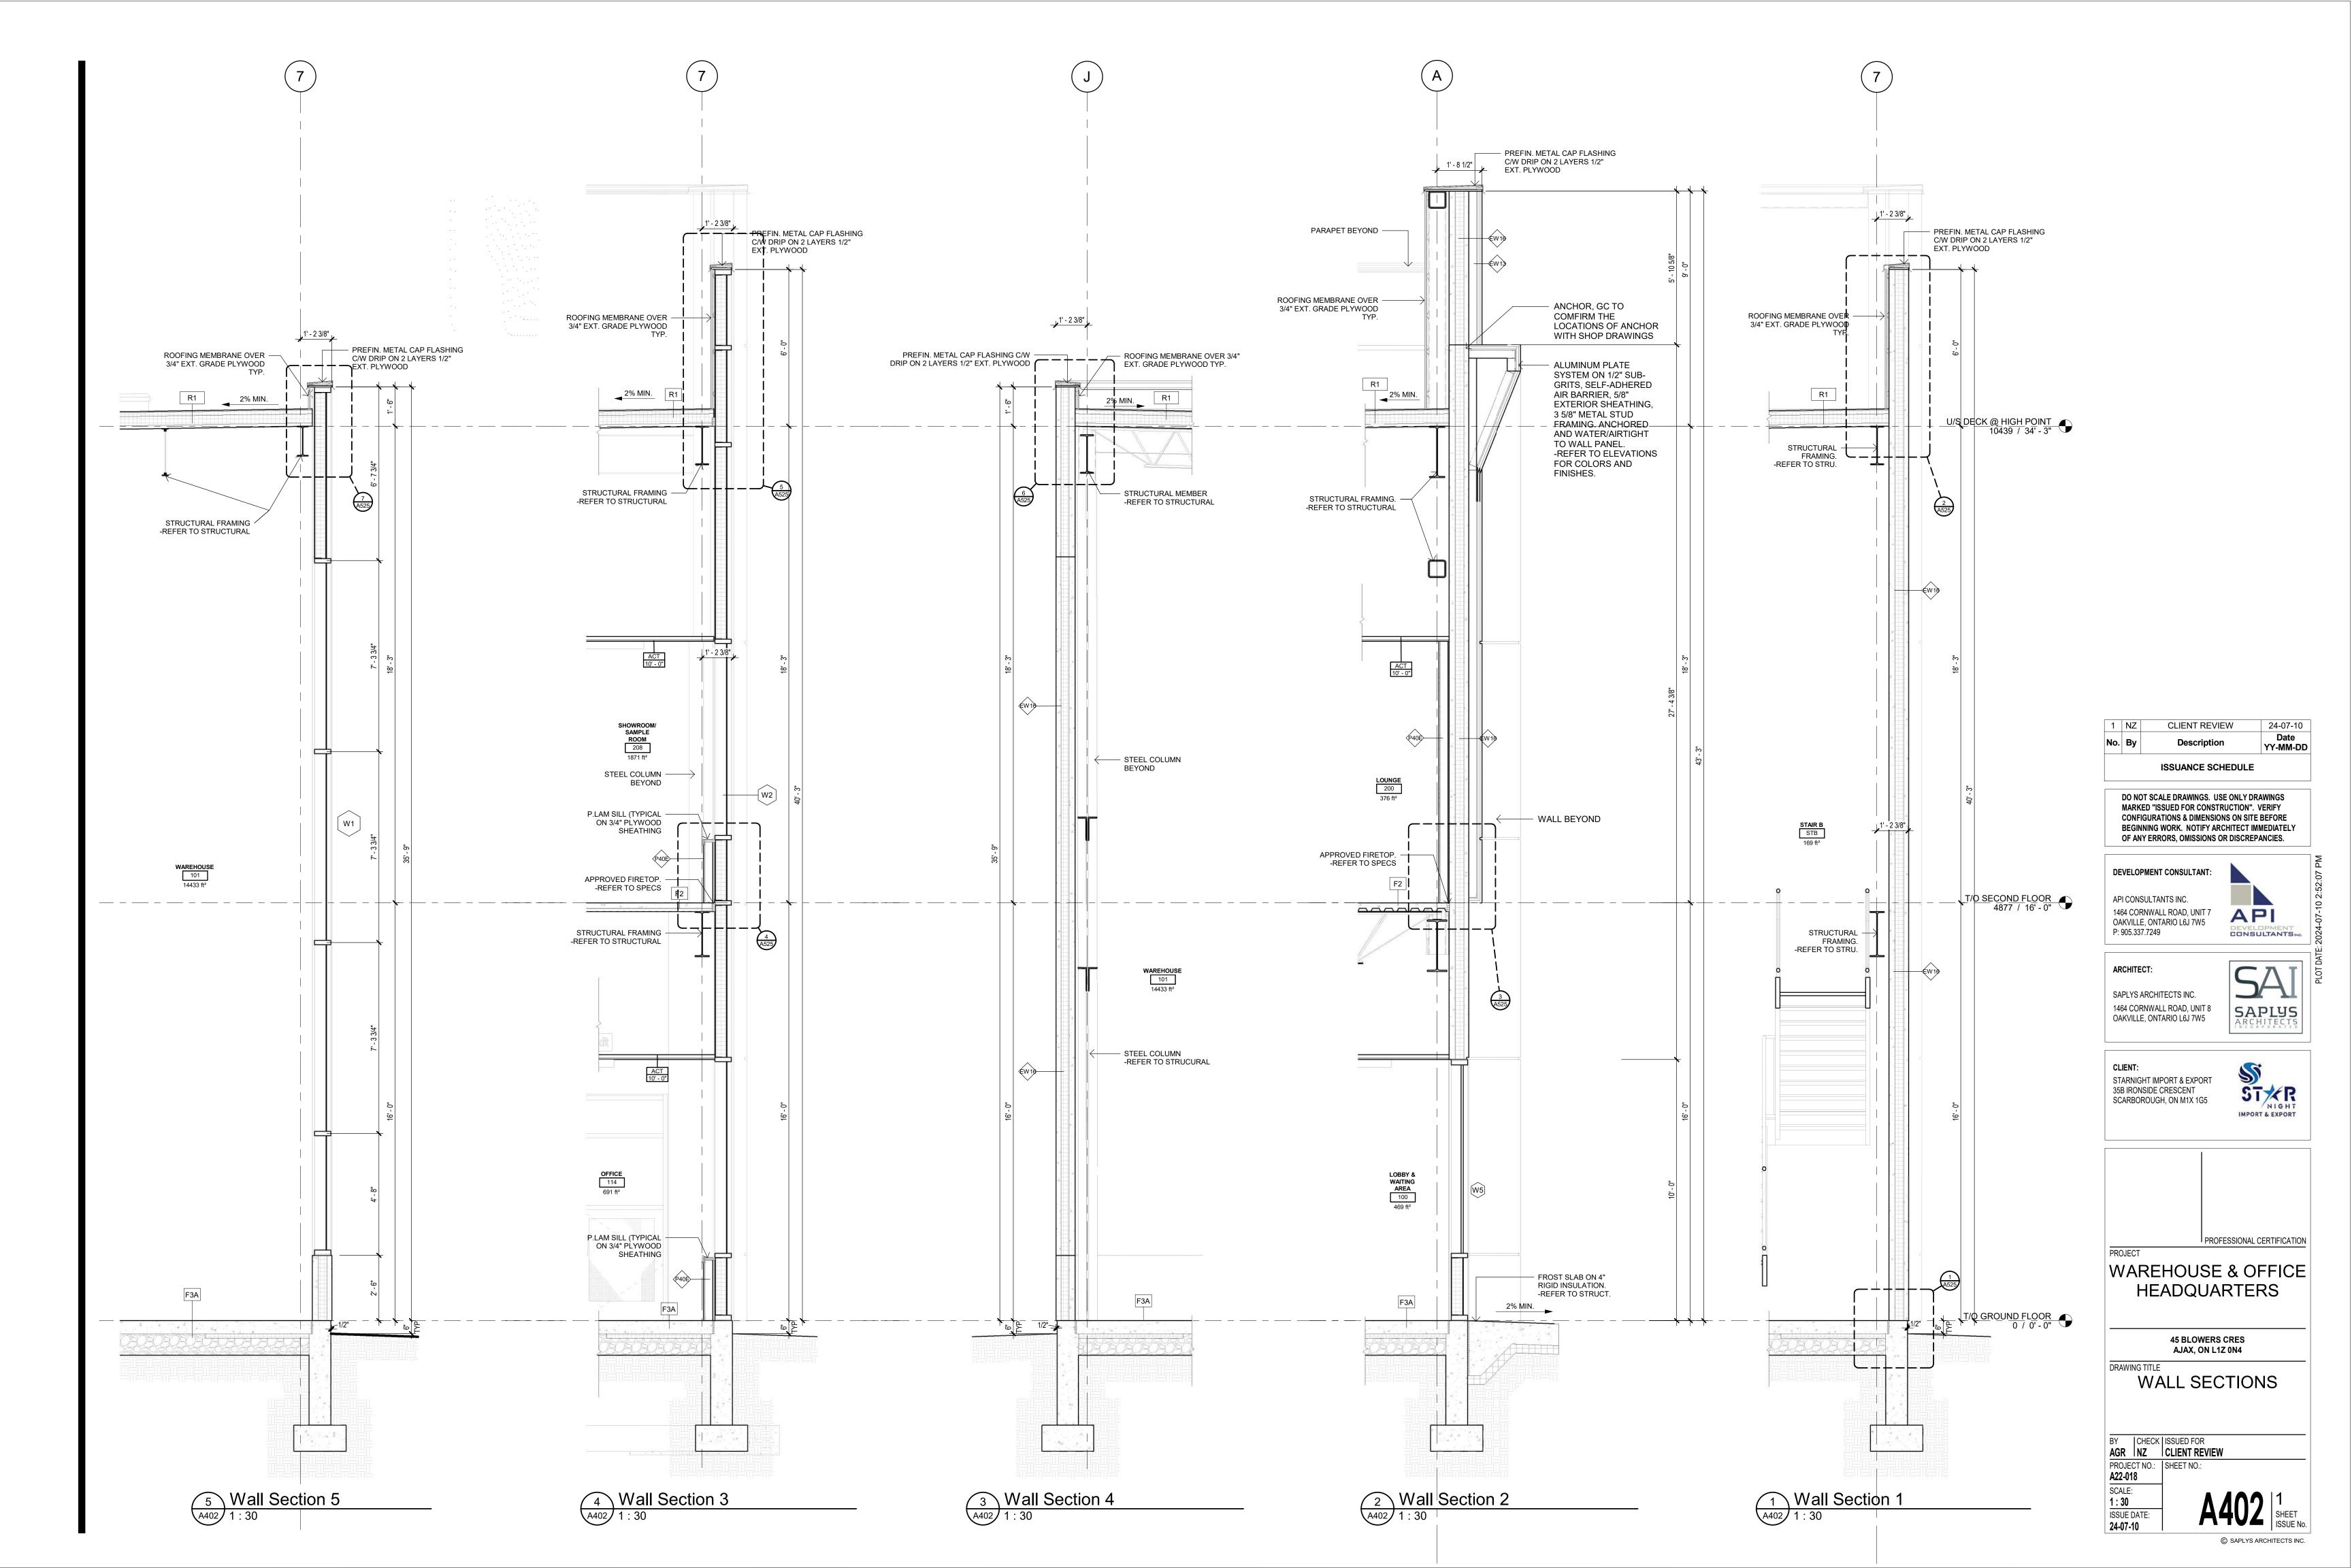


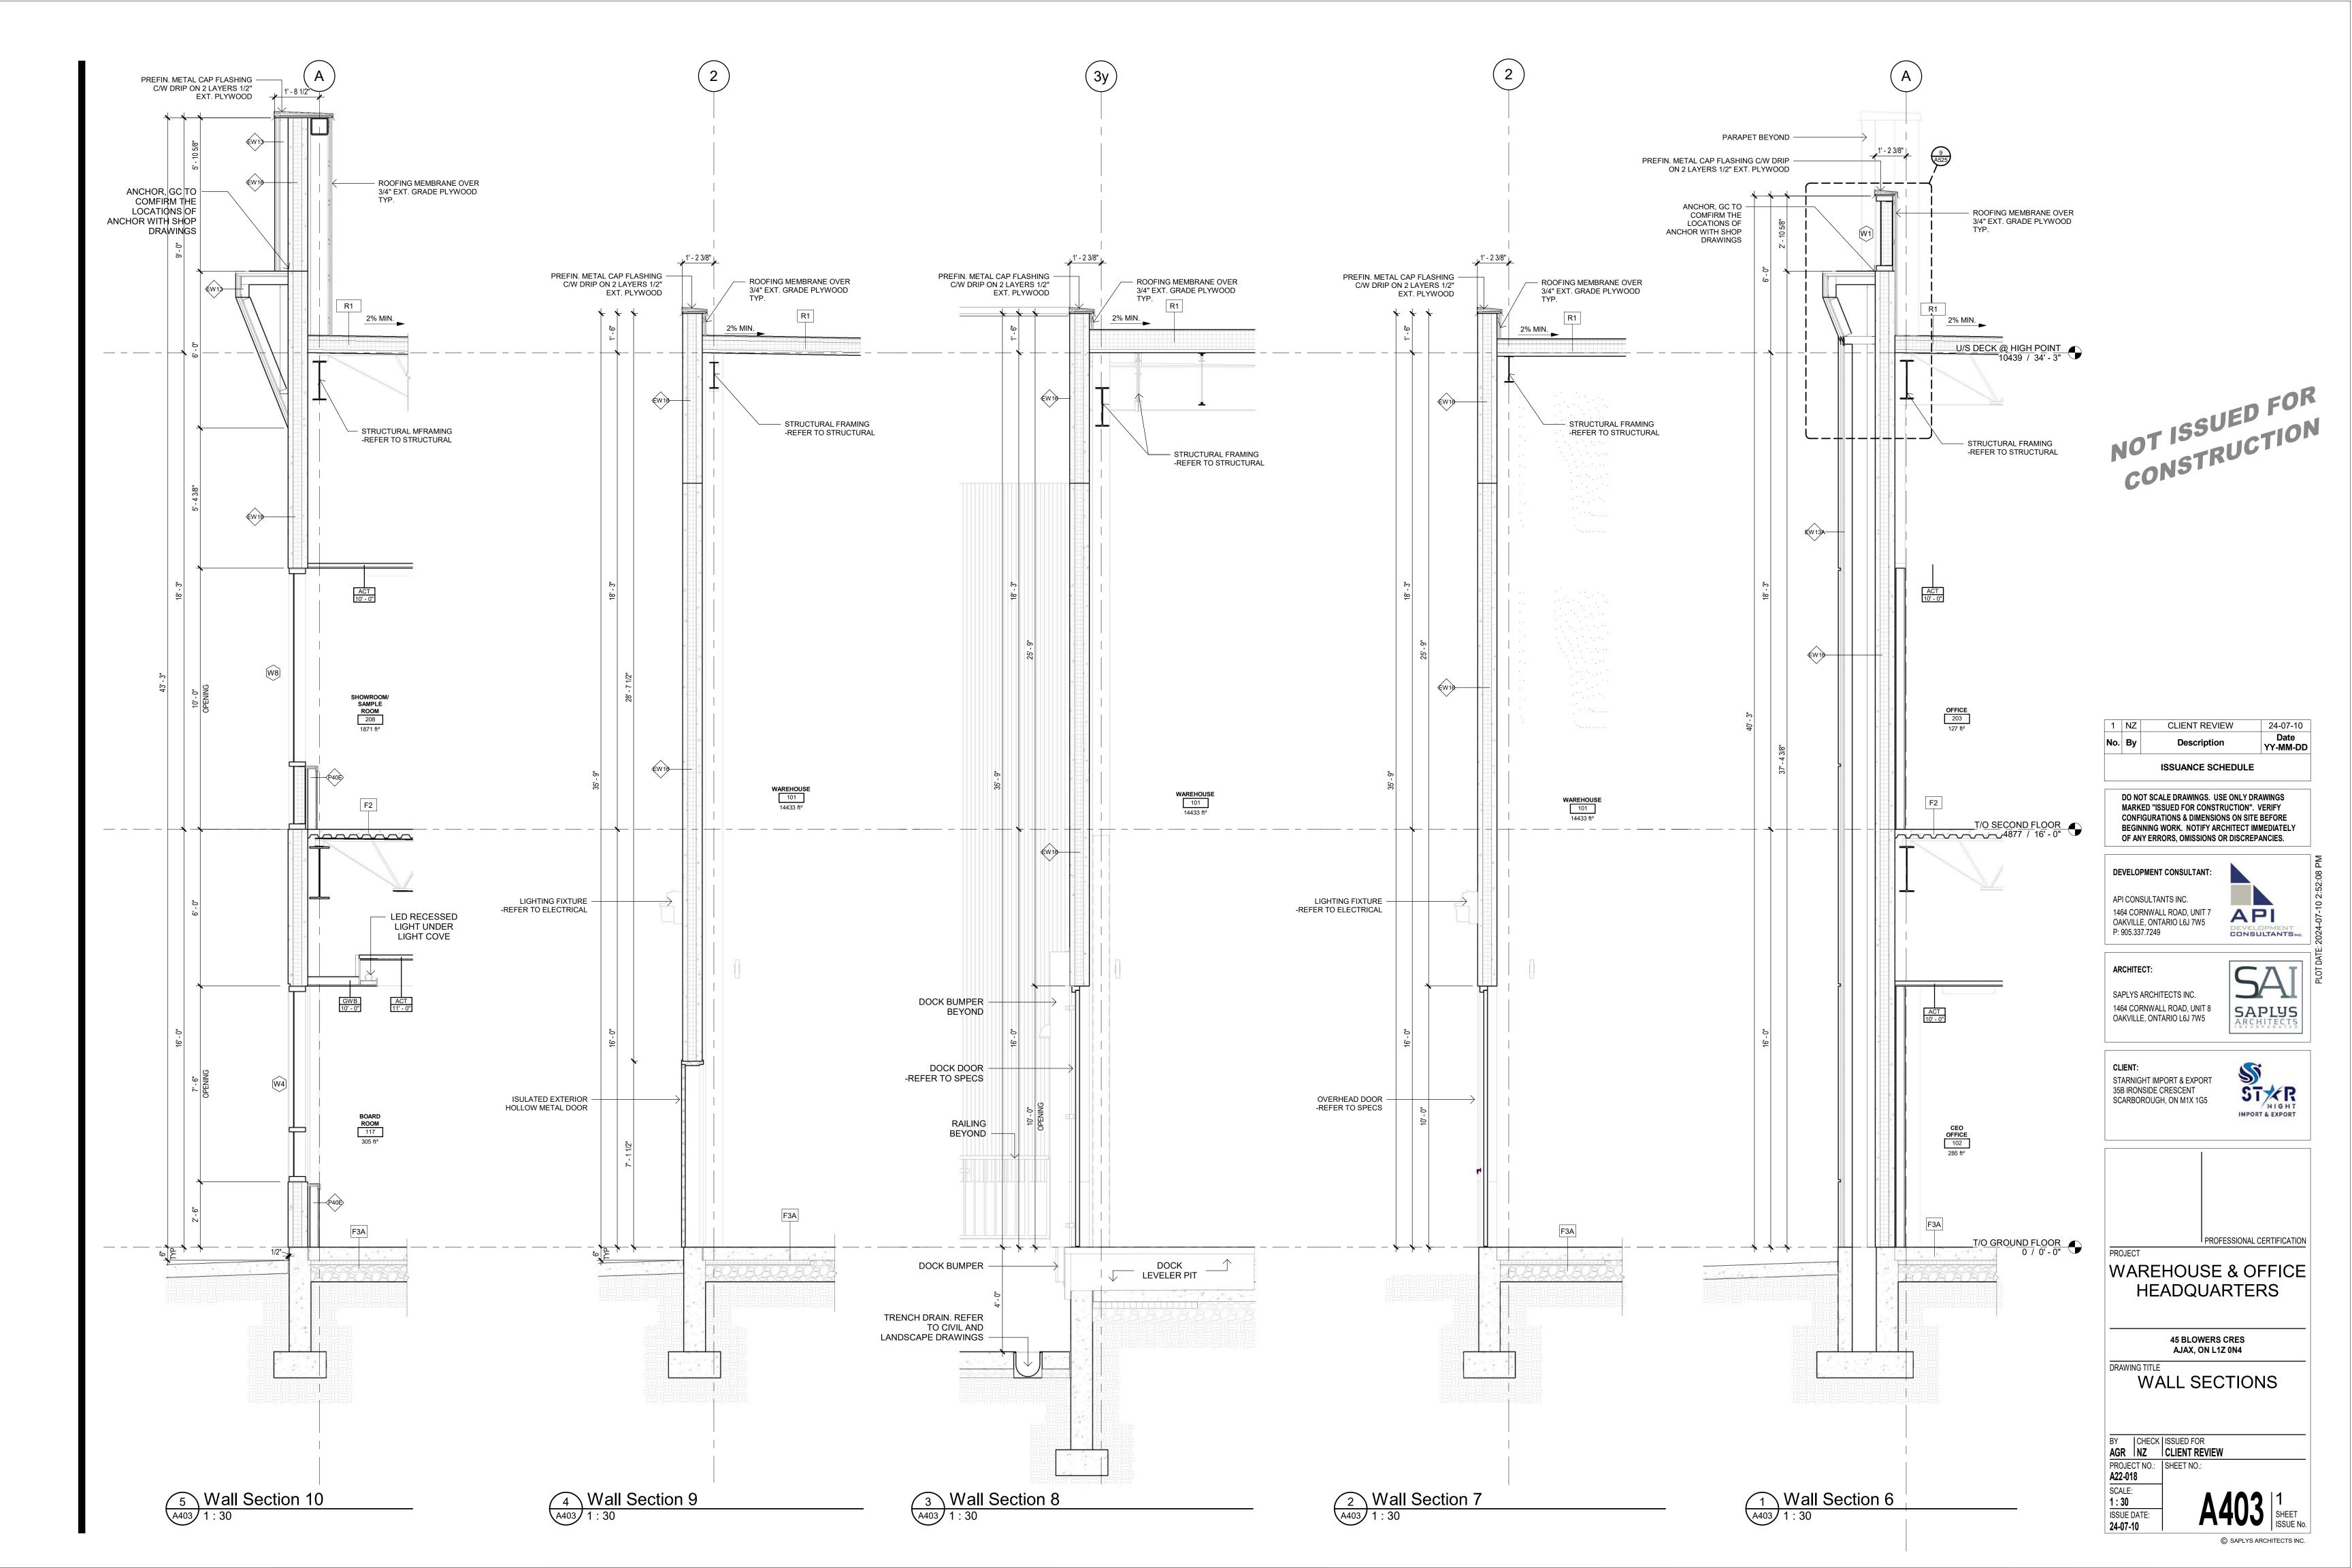

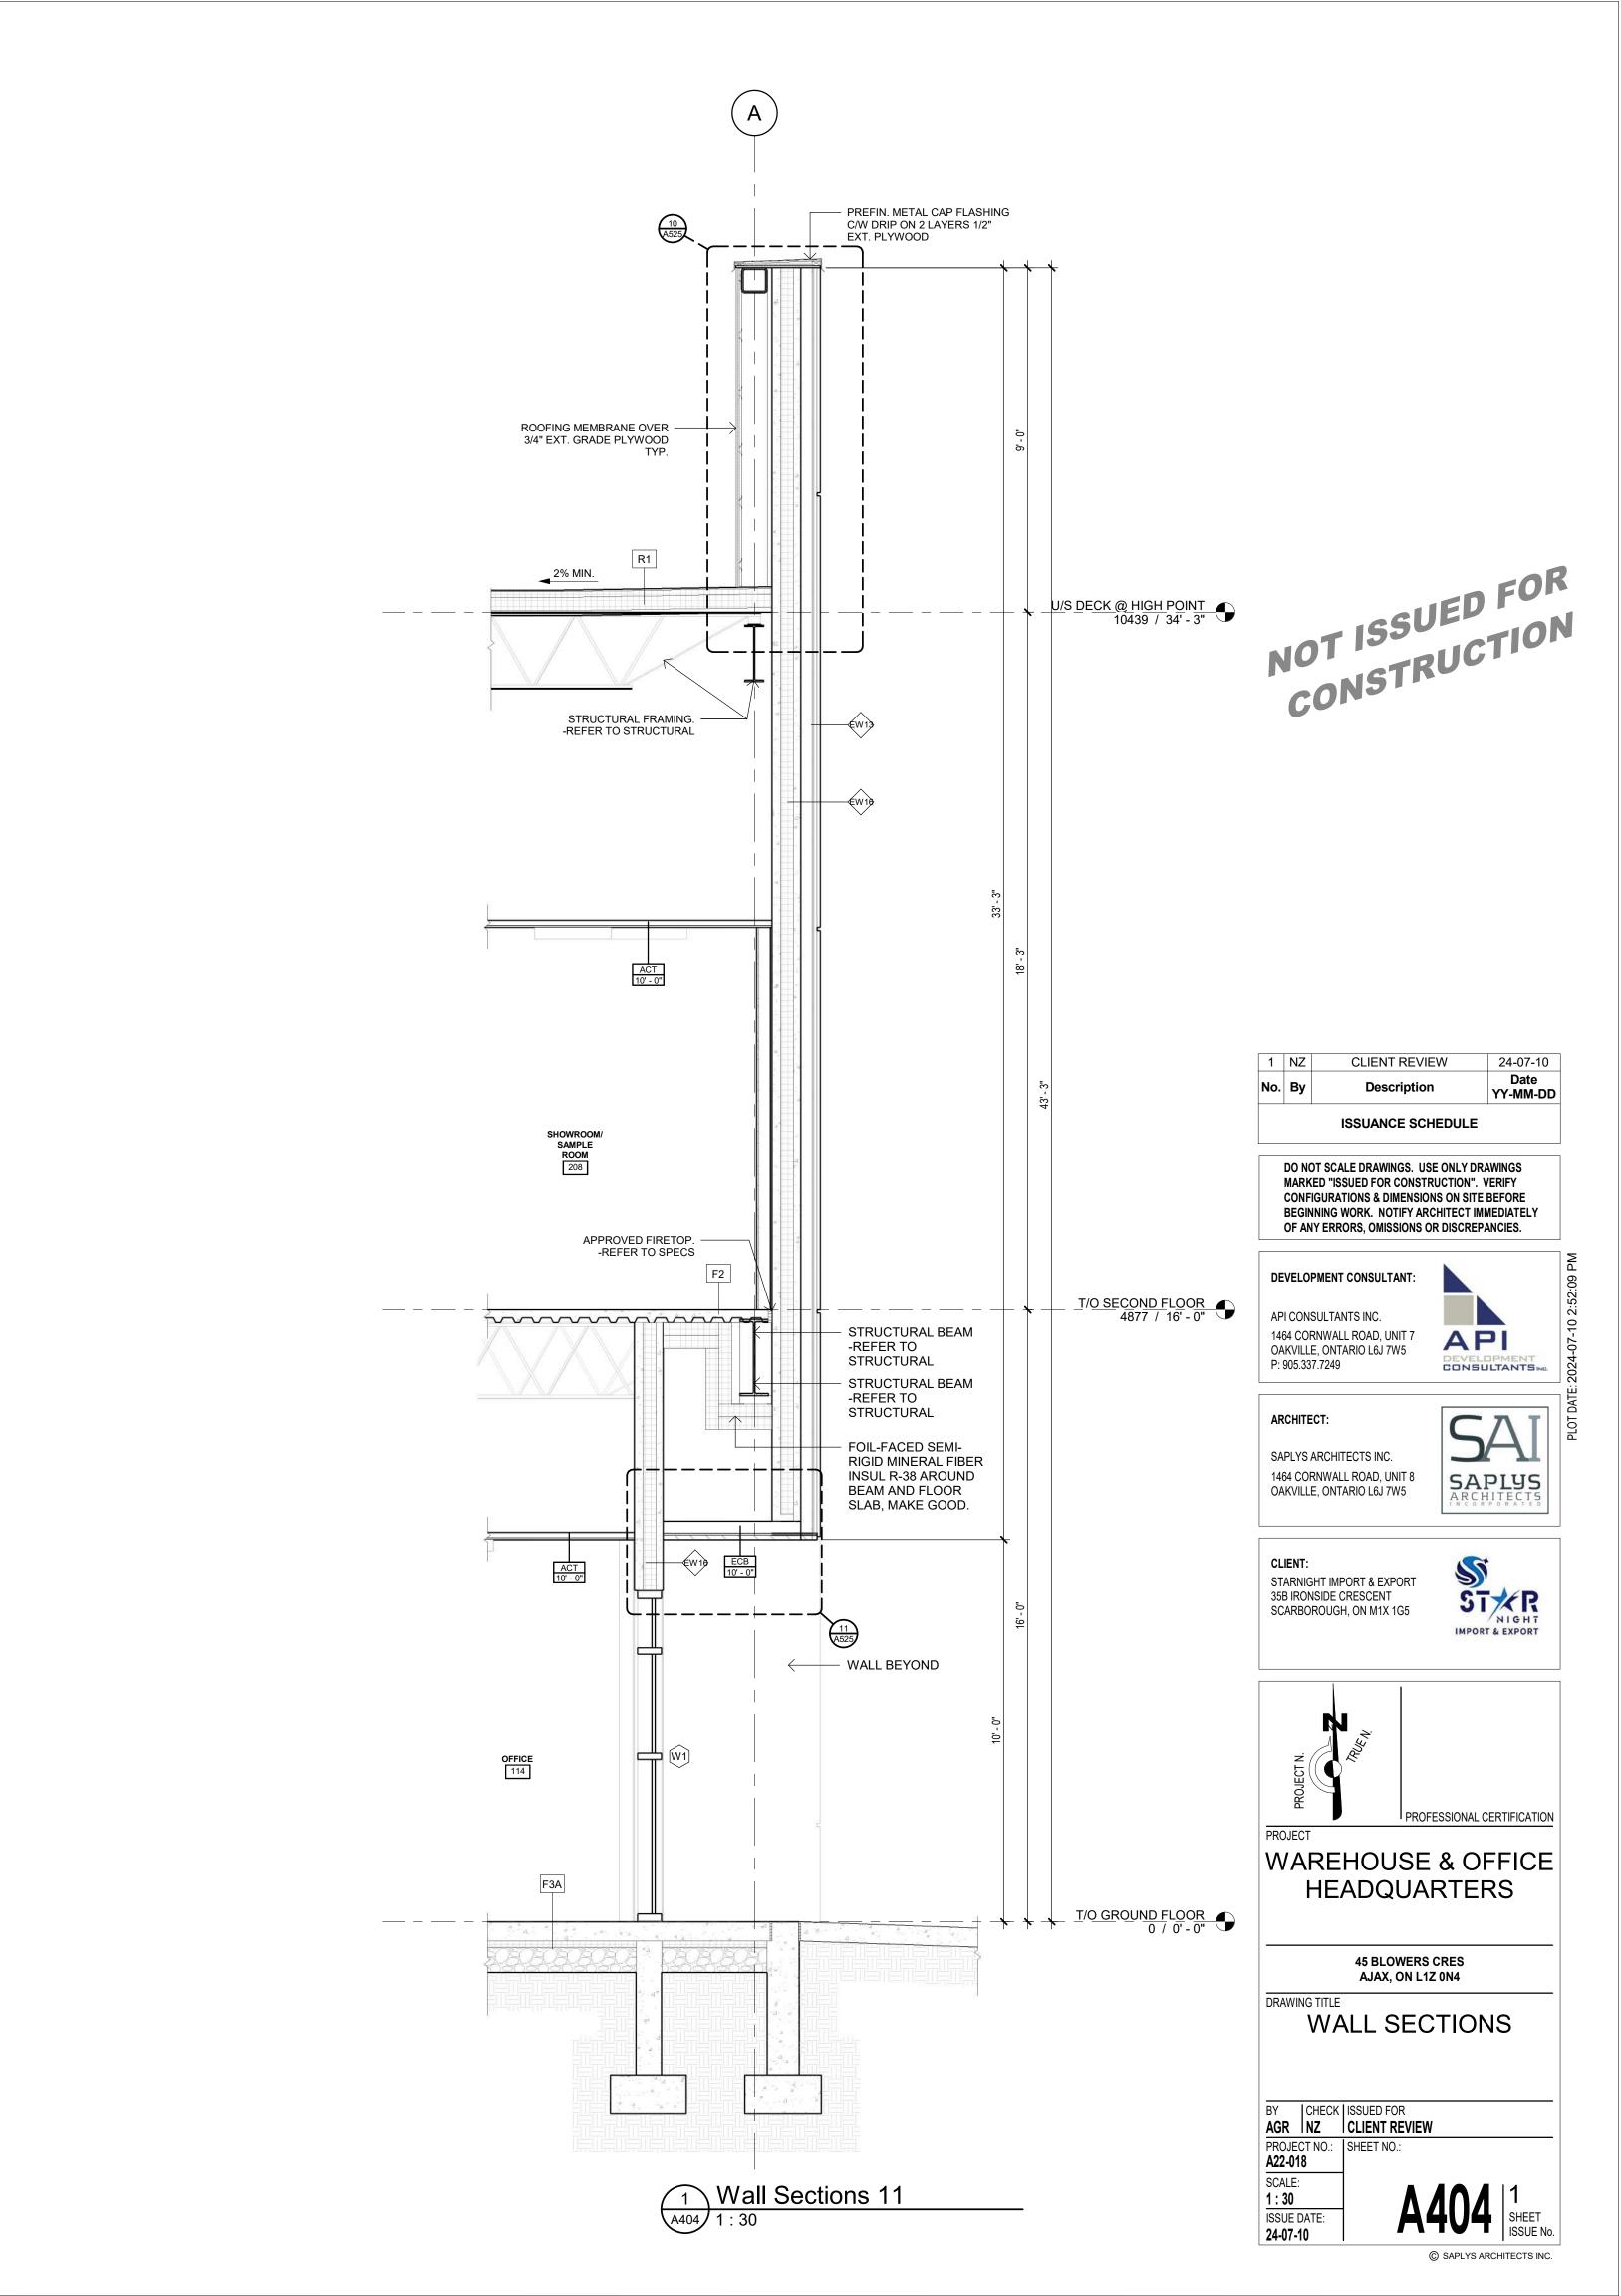


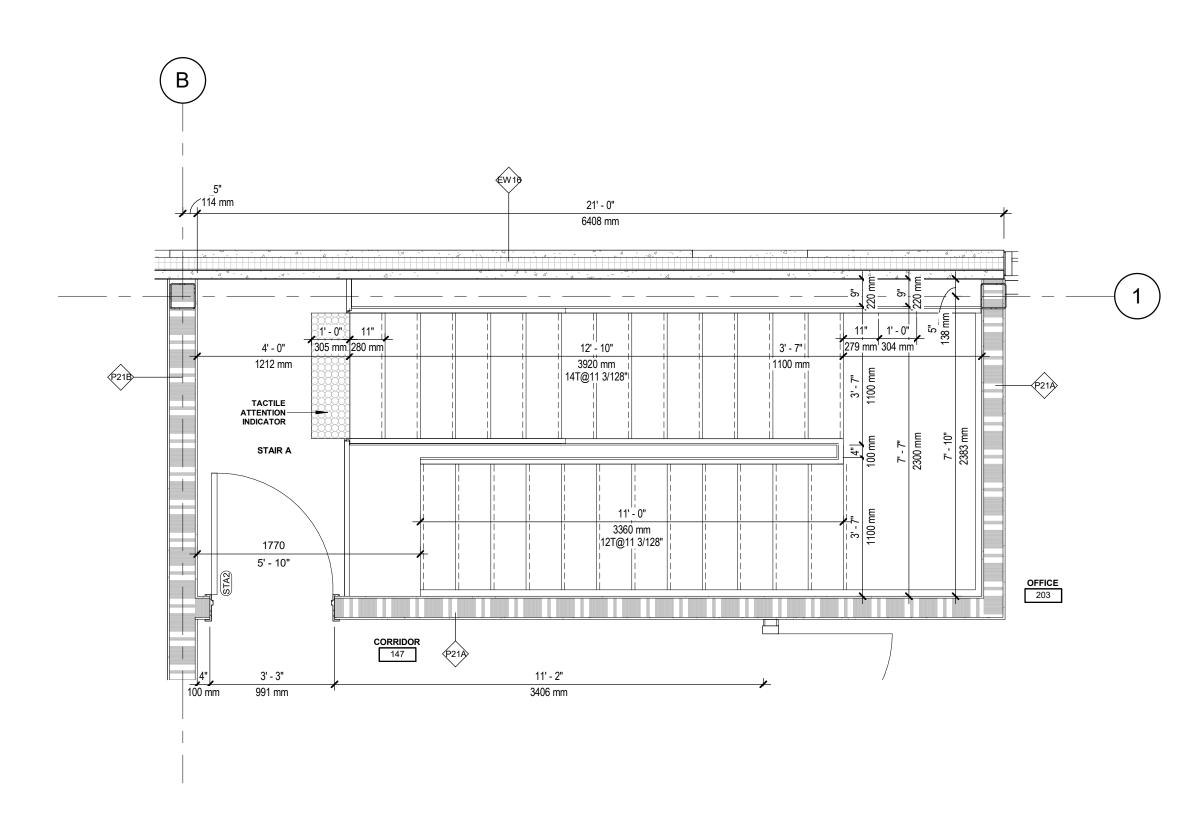

1 SECOND FLOOR PLAN -STAIR A
A500 1:30

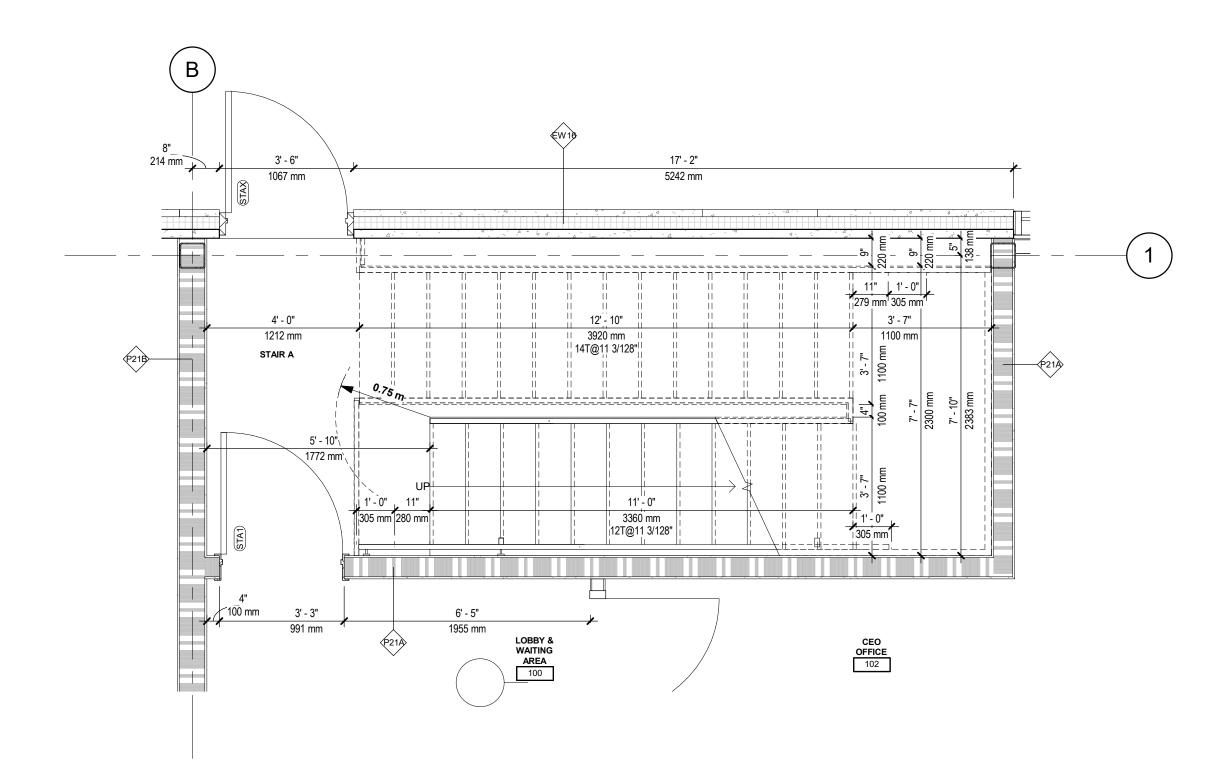


2 GROUND FLOOR PLAN STAIR A
A500 1:30

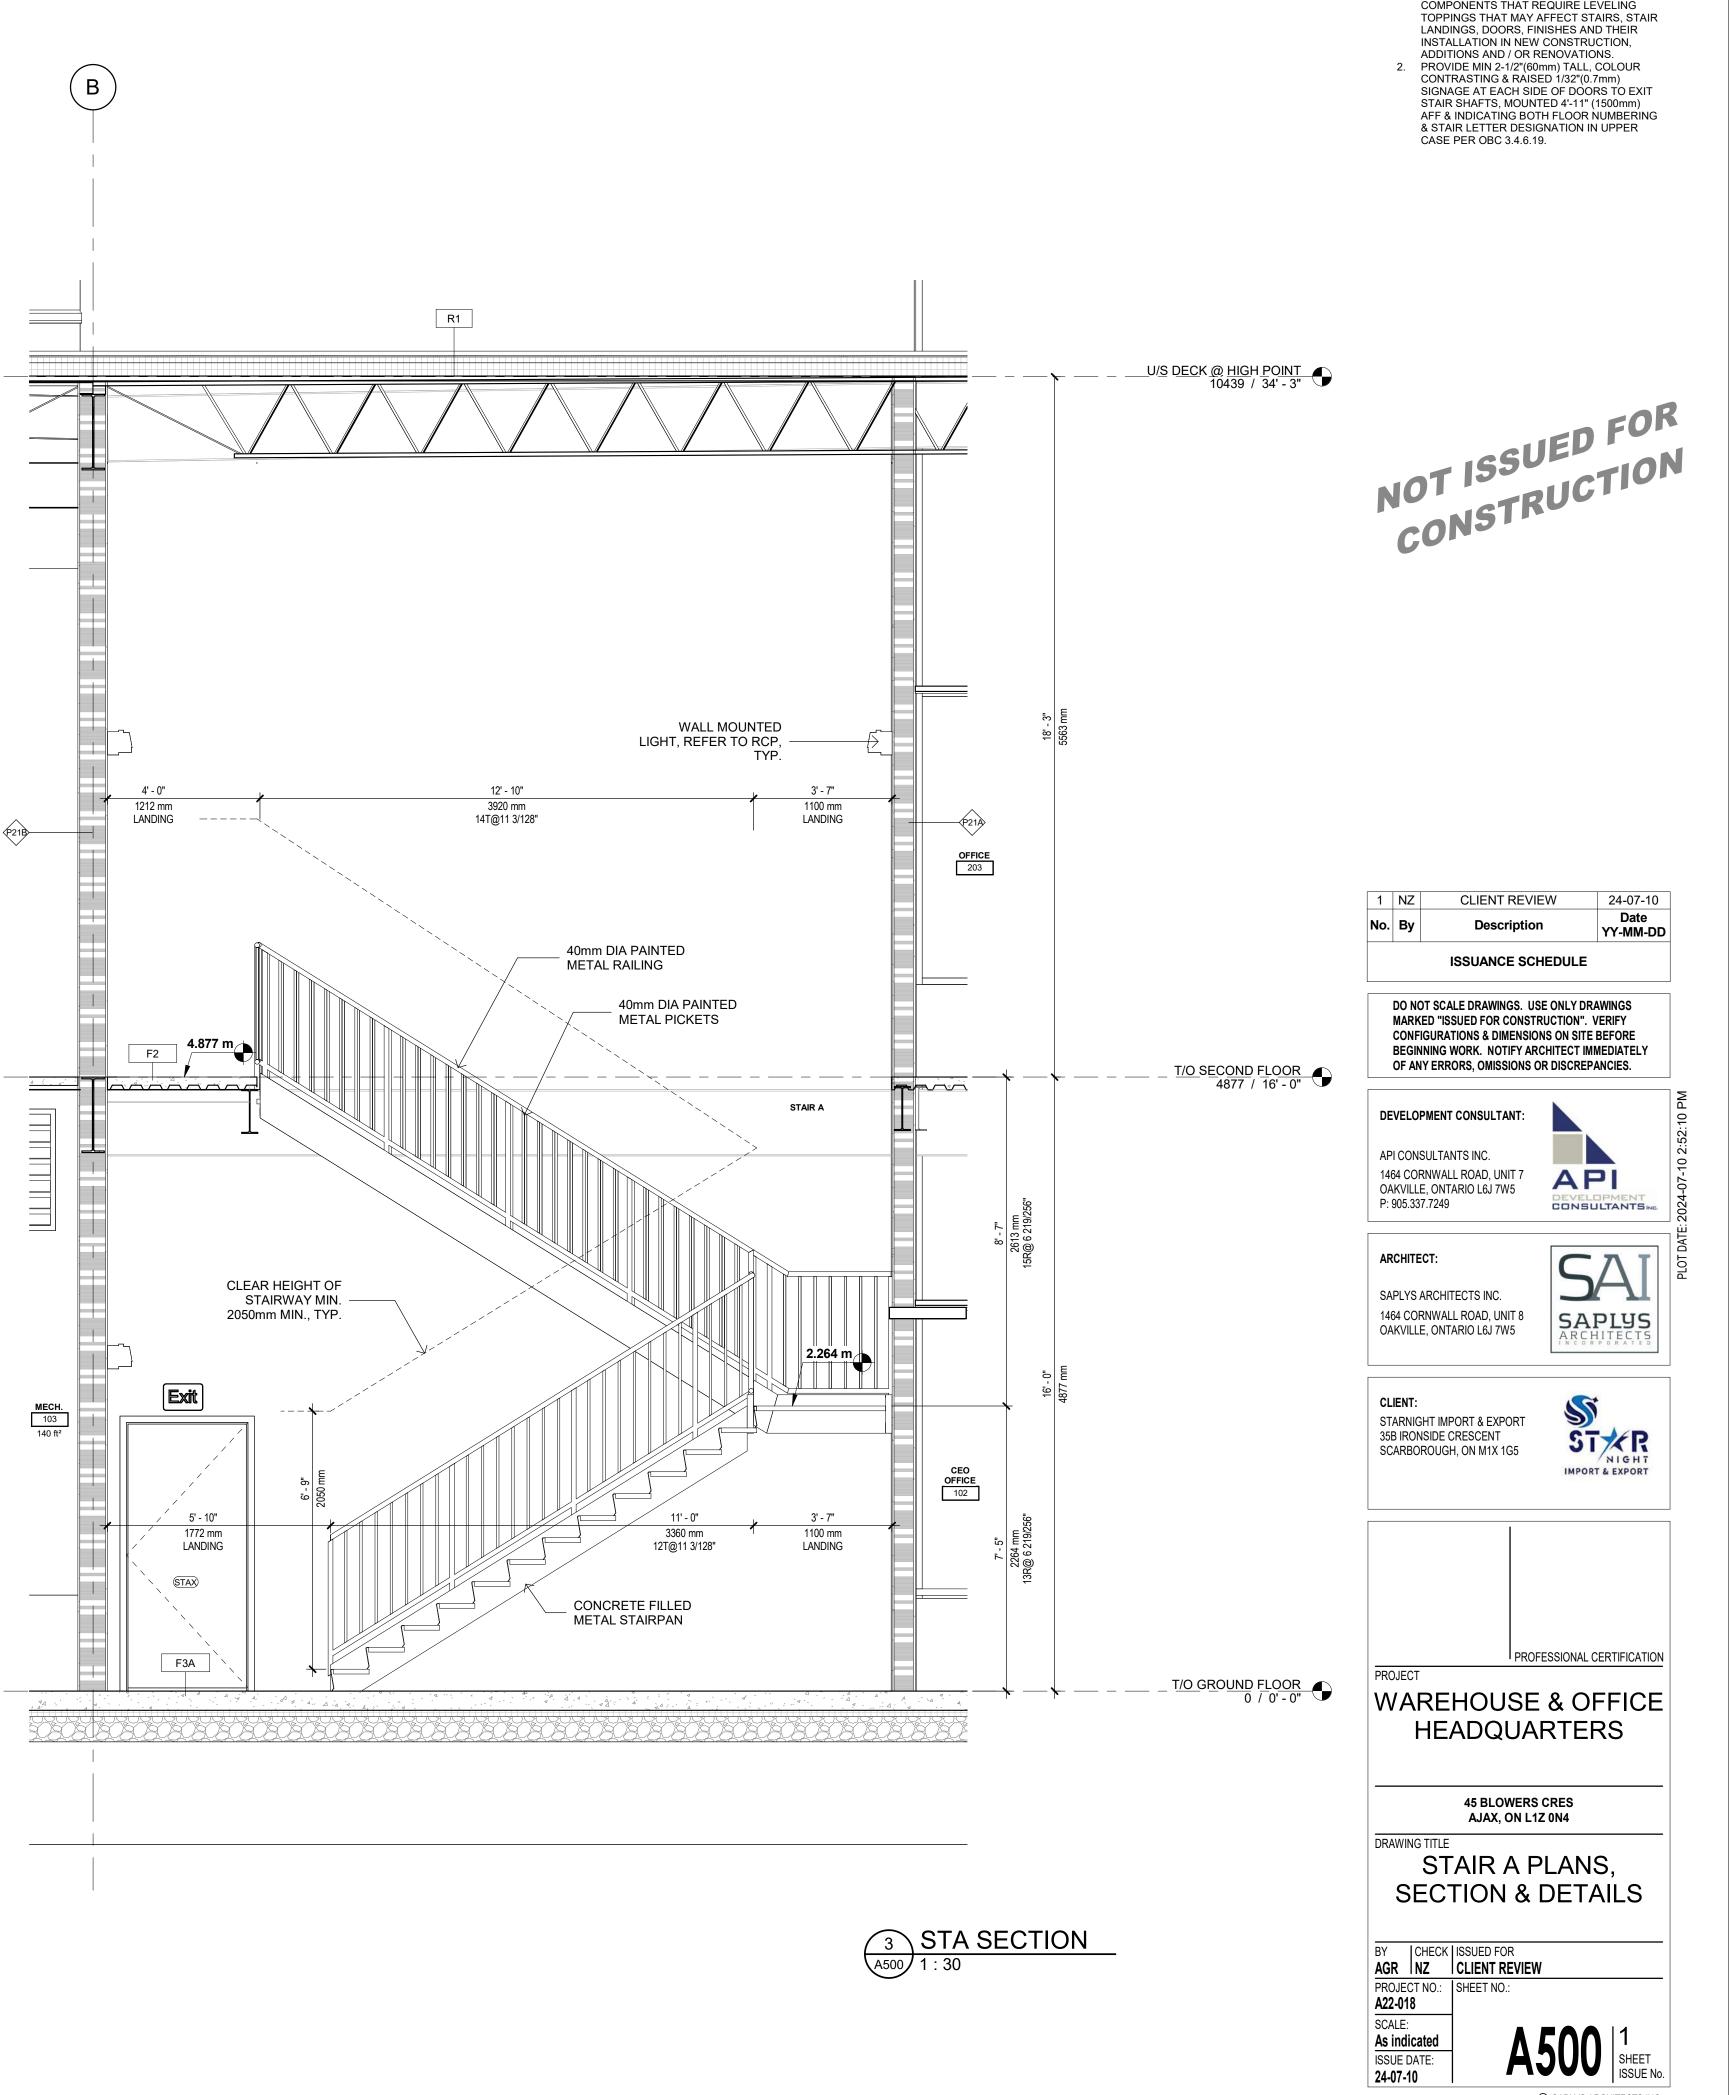


STAIR NOTES:


1. FLOOR DATUMS ON DRAWINGS ARE TO TOP OF FINISHED FLOOR(S). CONTRACTOR IS RESPONSIBLE FOR ACCOUNTING FOR CAMBERS IN STRUCTURAL FLOOR COMPONENTS THAT REQUIRE LEVELING

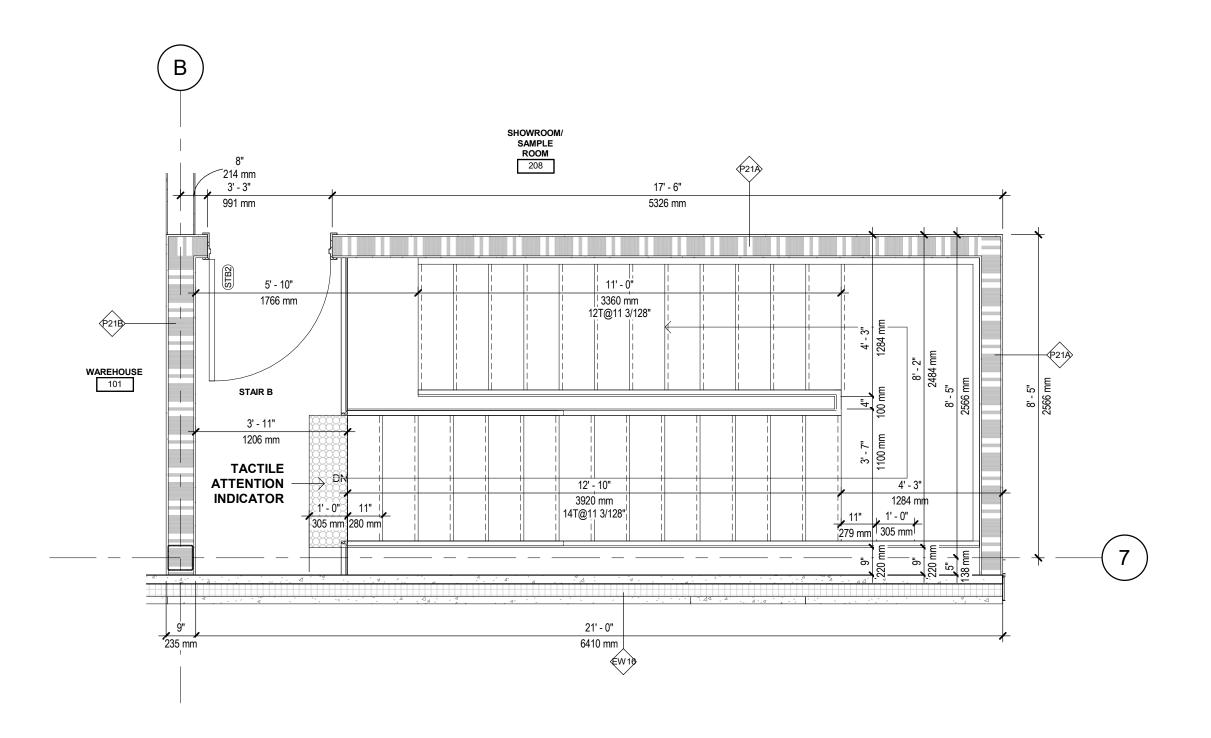


1 SECOND FLOOR PLAN -STAIR B
A501 1:30

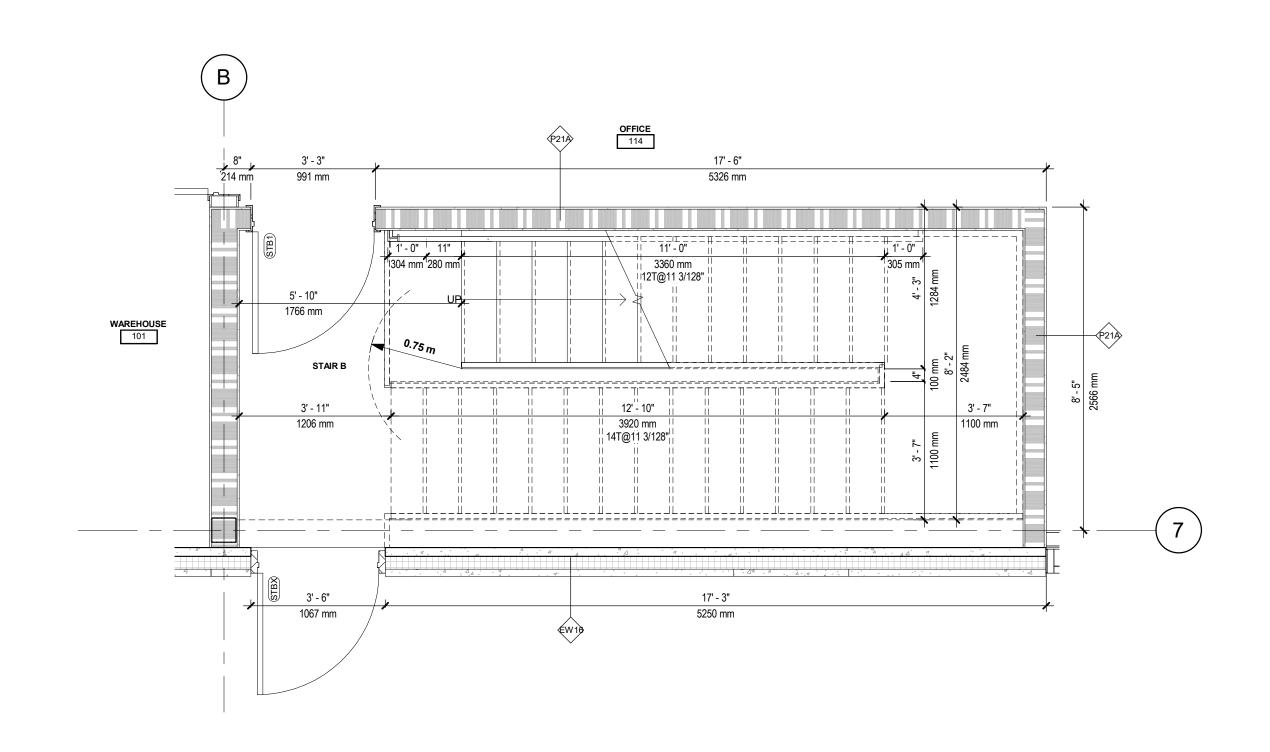




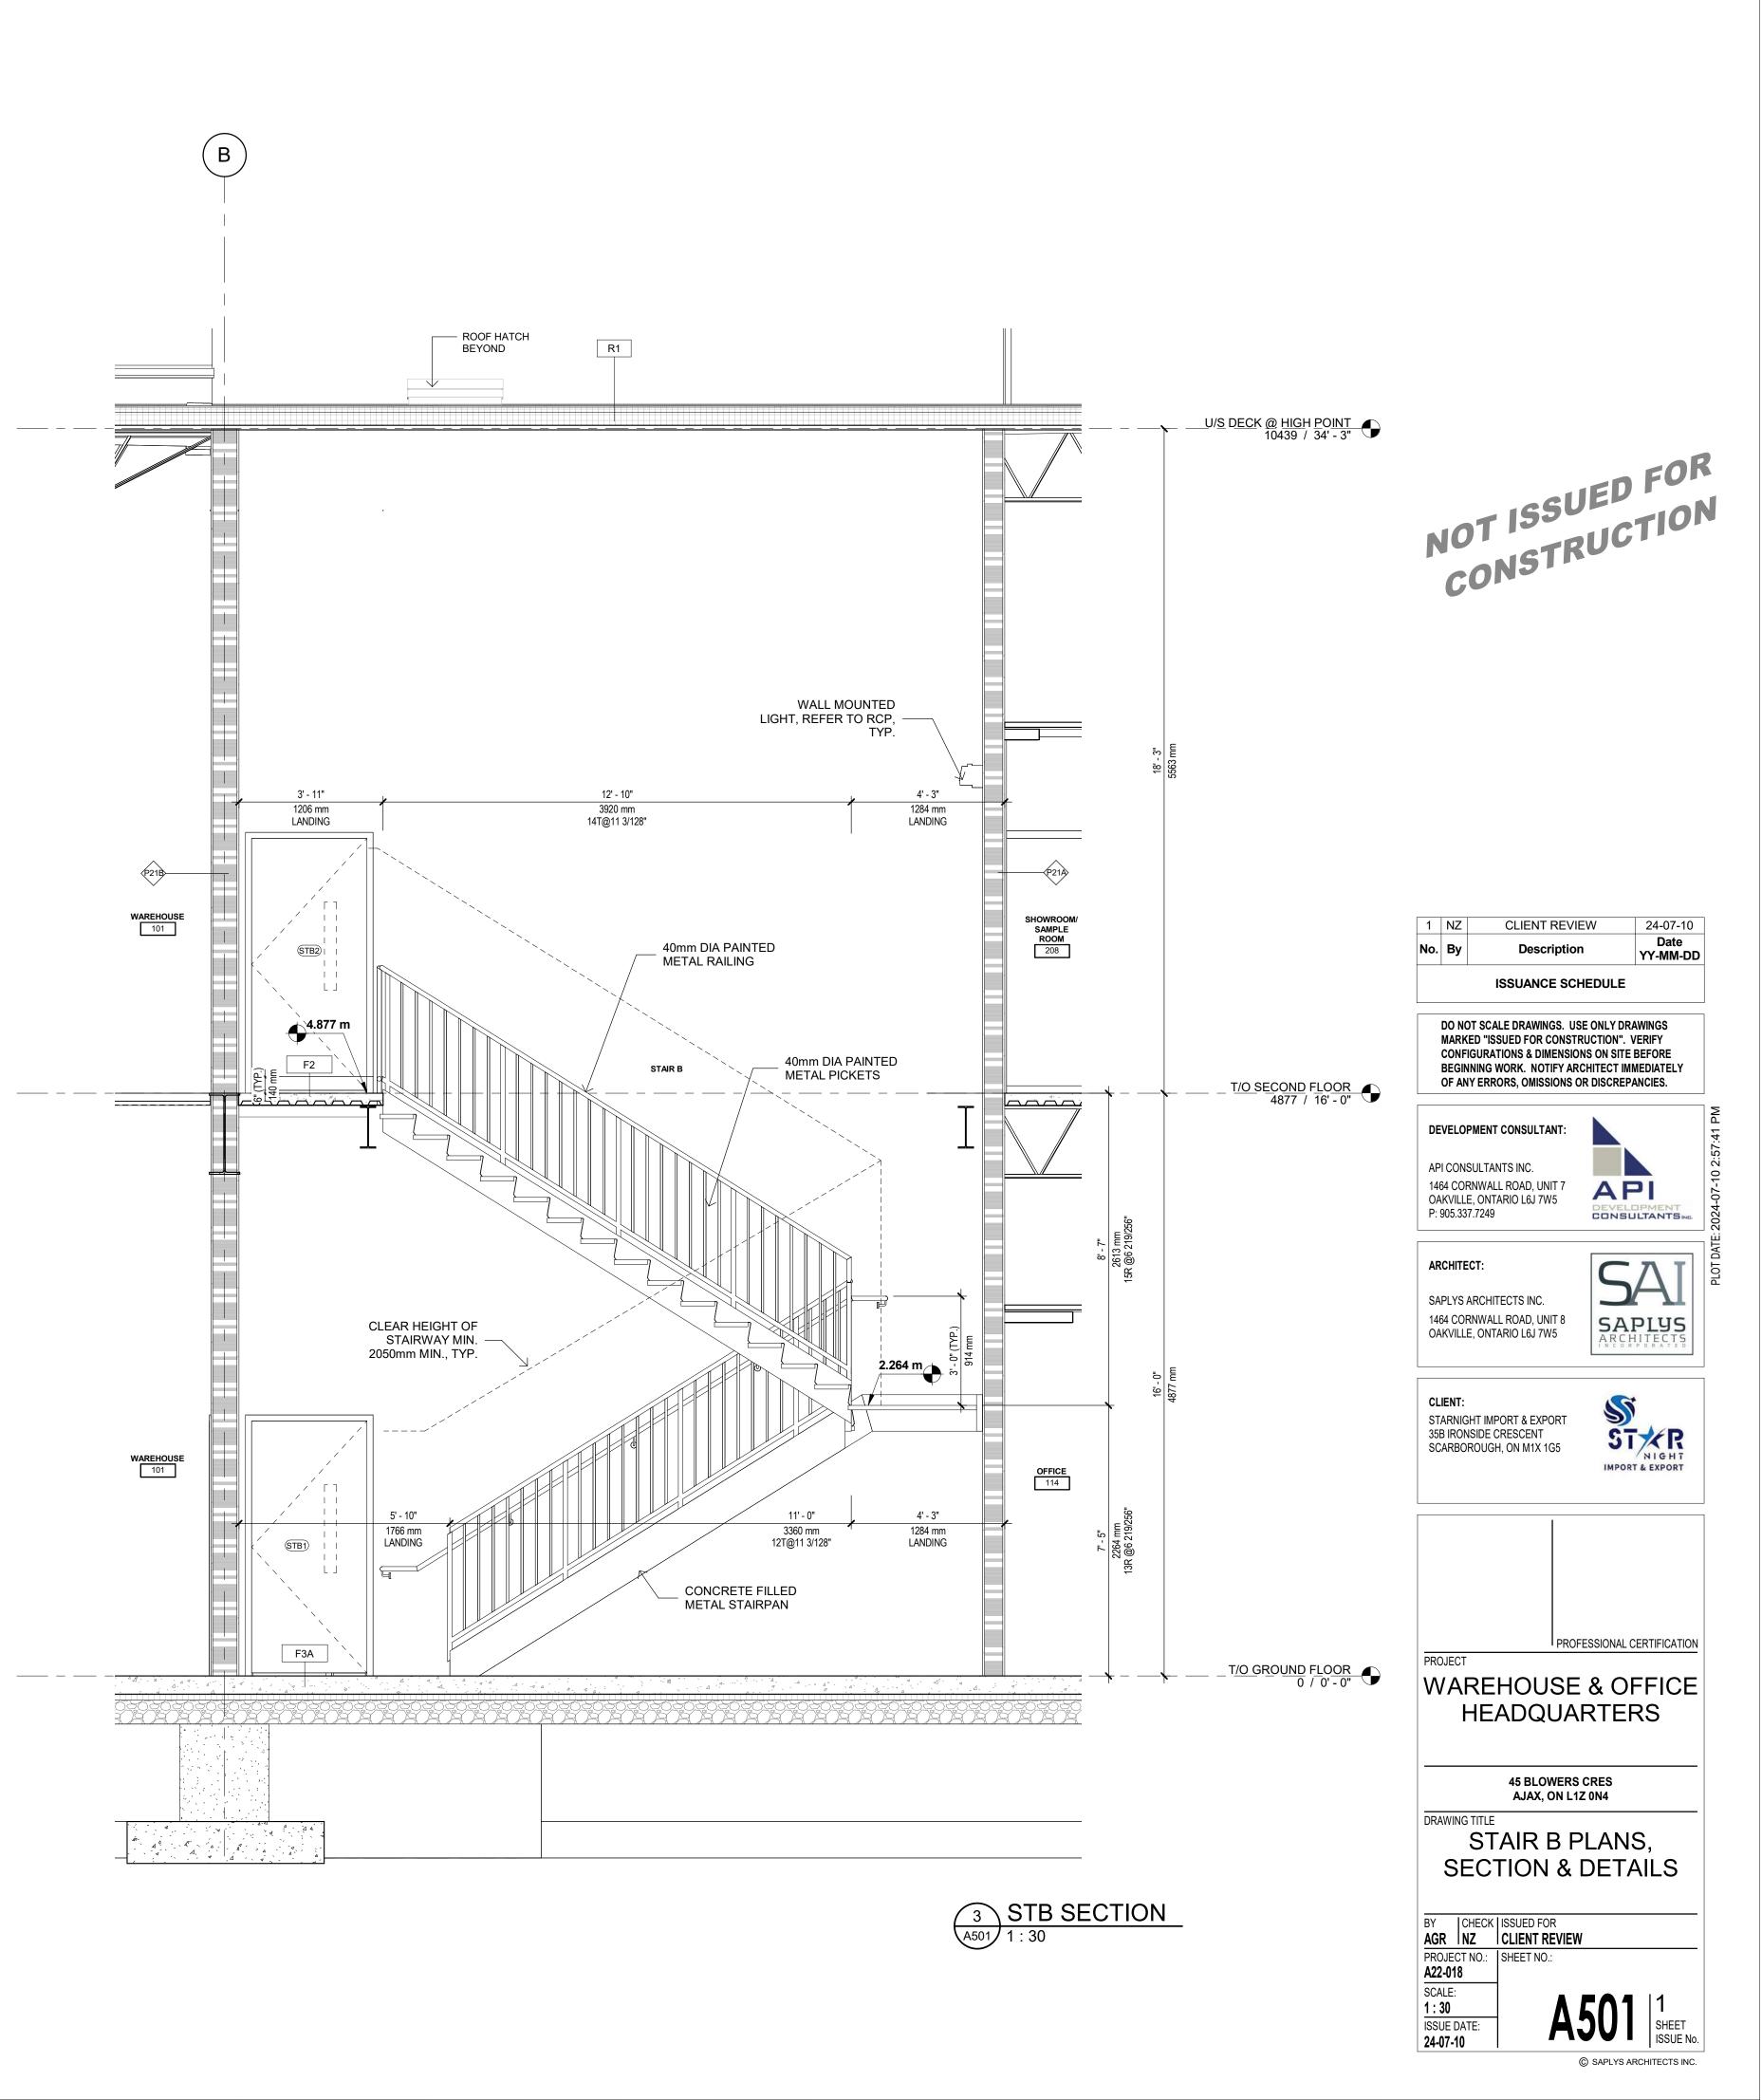


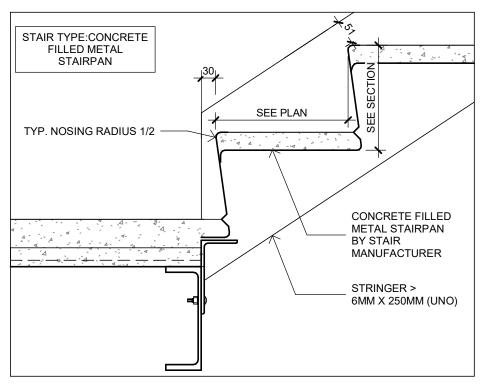




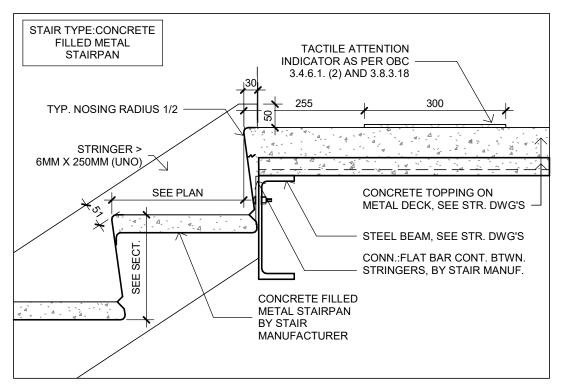


5 DETAIL @TOP OF LANDING
A502 1 1/2" = 1'-0"

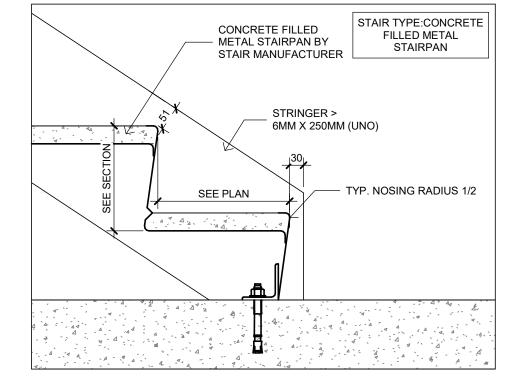

3 DETAIL @BOTTOM OF STAIR
A502 1 1/2" = 1'-0"

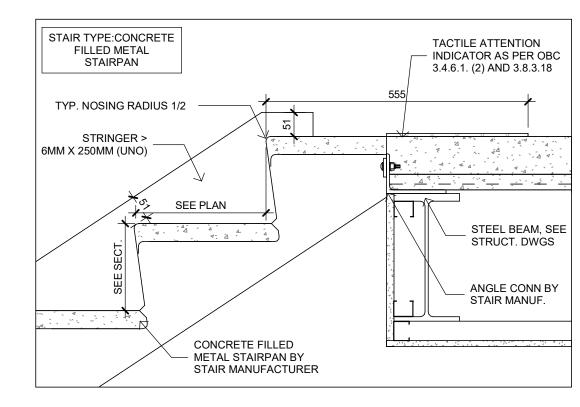


6 DETAIL @TOP OF STAIR
A502 1 1/2" = 1'-0"

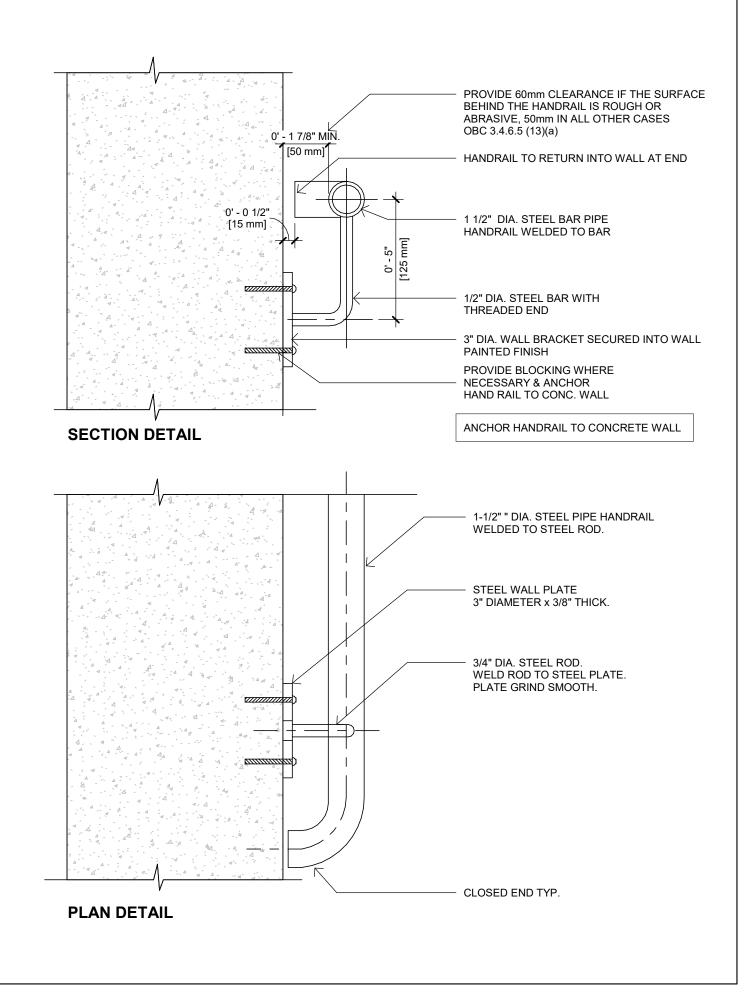


4 STAIR HANDRAIL @ CONC. WALL TYP.

A502 3" = 1'-0"

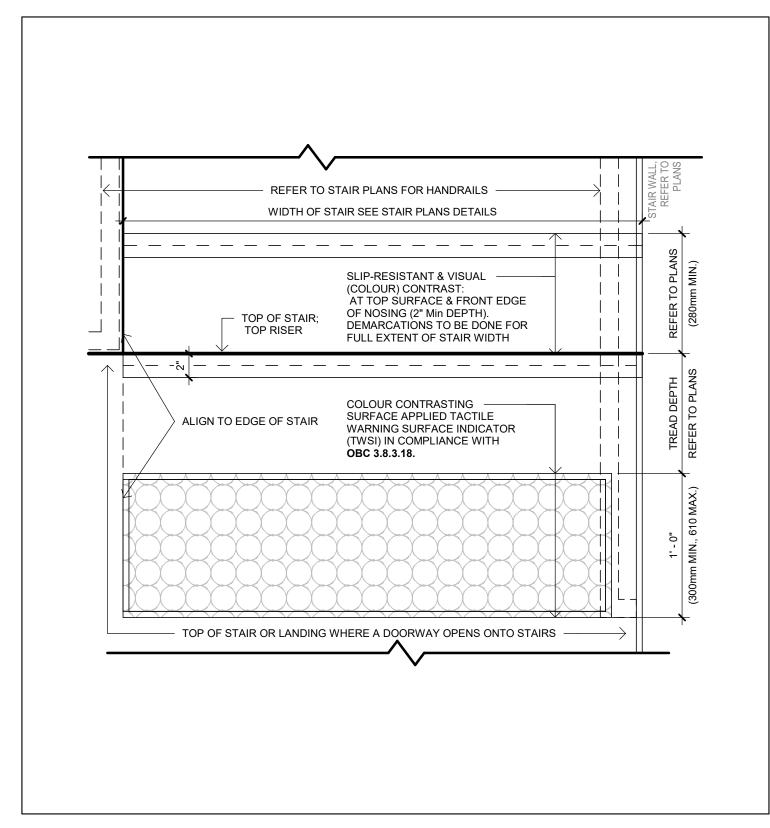

1 STAIR PLAN DETAIL @ LANDING (TYPICAL)
A502 1 1/2" = 1'-0"

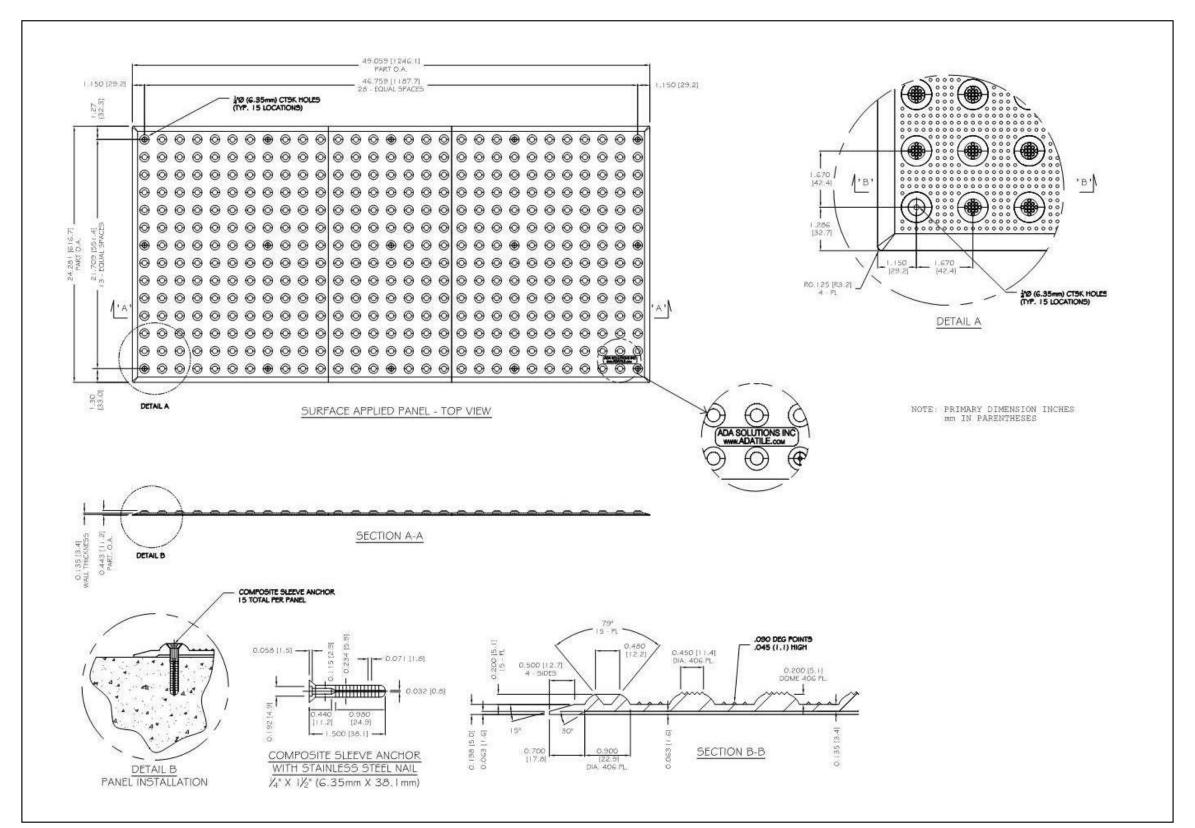

DETECTABLE WARNING SURFACE DETAIL



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ISSUANCE SCHEDULE

24-07-10


YY-MM-DD

CONSULTANTS

1 NZ

ARCHITECT: SAPLYS ARCHITECTS INC. 1464 CORNWALL ROAD, UNIT 8 OAKVILLE, ONTARIO L6J 7W5

STARNIGHT IMPORT & EXPORT 35B IRONSIDE CRESCENT SCARBOROUGH, ON M1X 1G5 NIGHT IMPORT & EXPORT

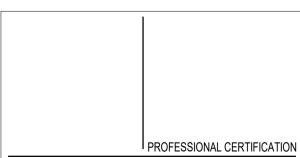


WAREHOUSE & OFFICE **HEADQUARTERS**

45 BLOWERS CRES AJAX, ON L1Z 0N4 TYPICAL STAIR **DETAILS**

BY CHECK ISSUED FOR AGR NZ CLIENT REVIEW PROJECT NO.: | SHEET NO.: A22-018 SCALE:

As indicated ISSUE DATE:

24-07-10

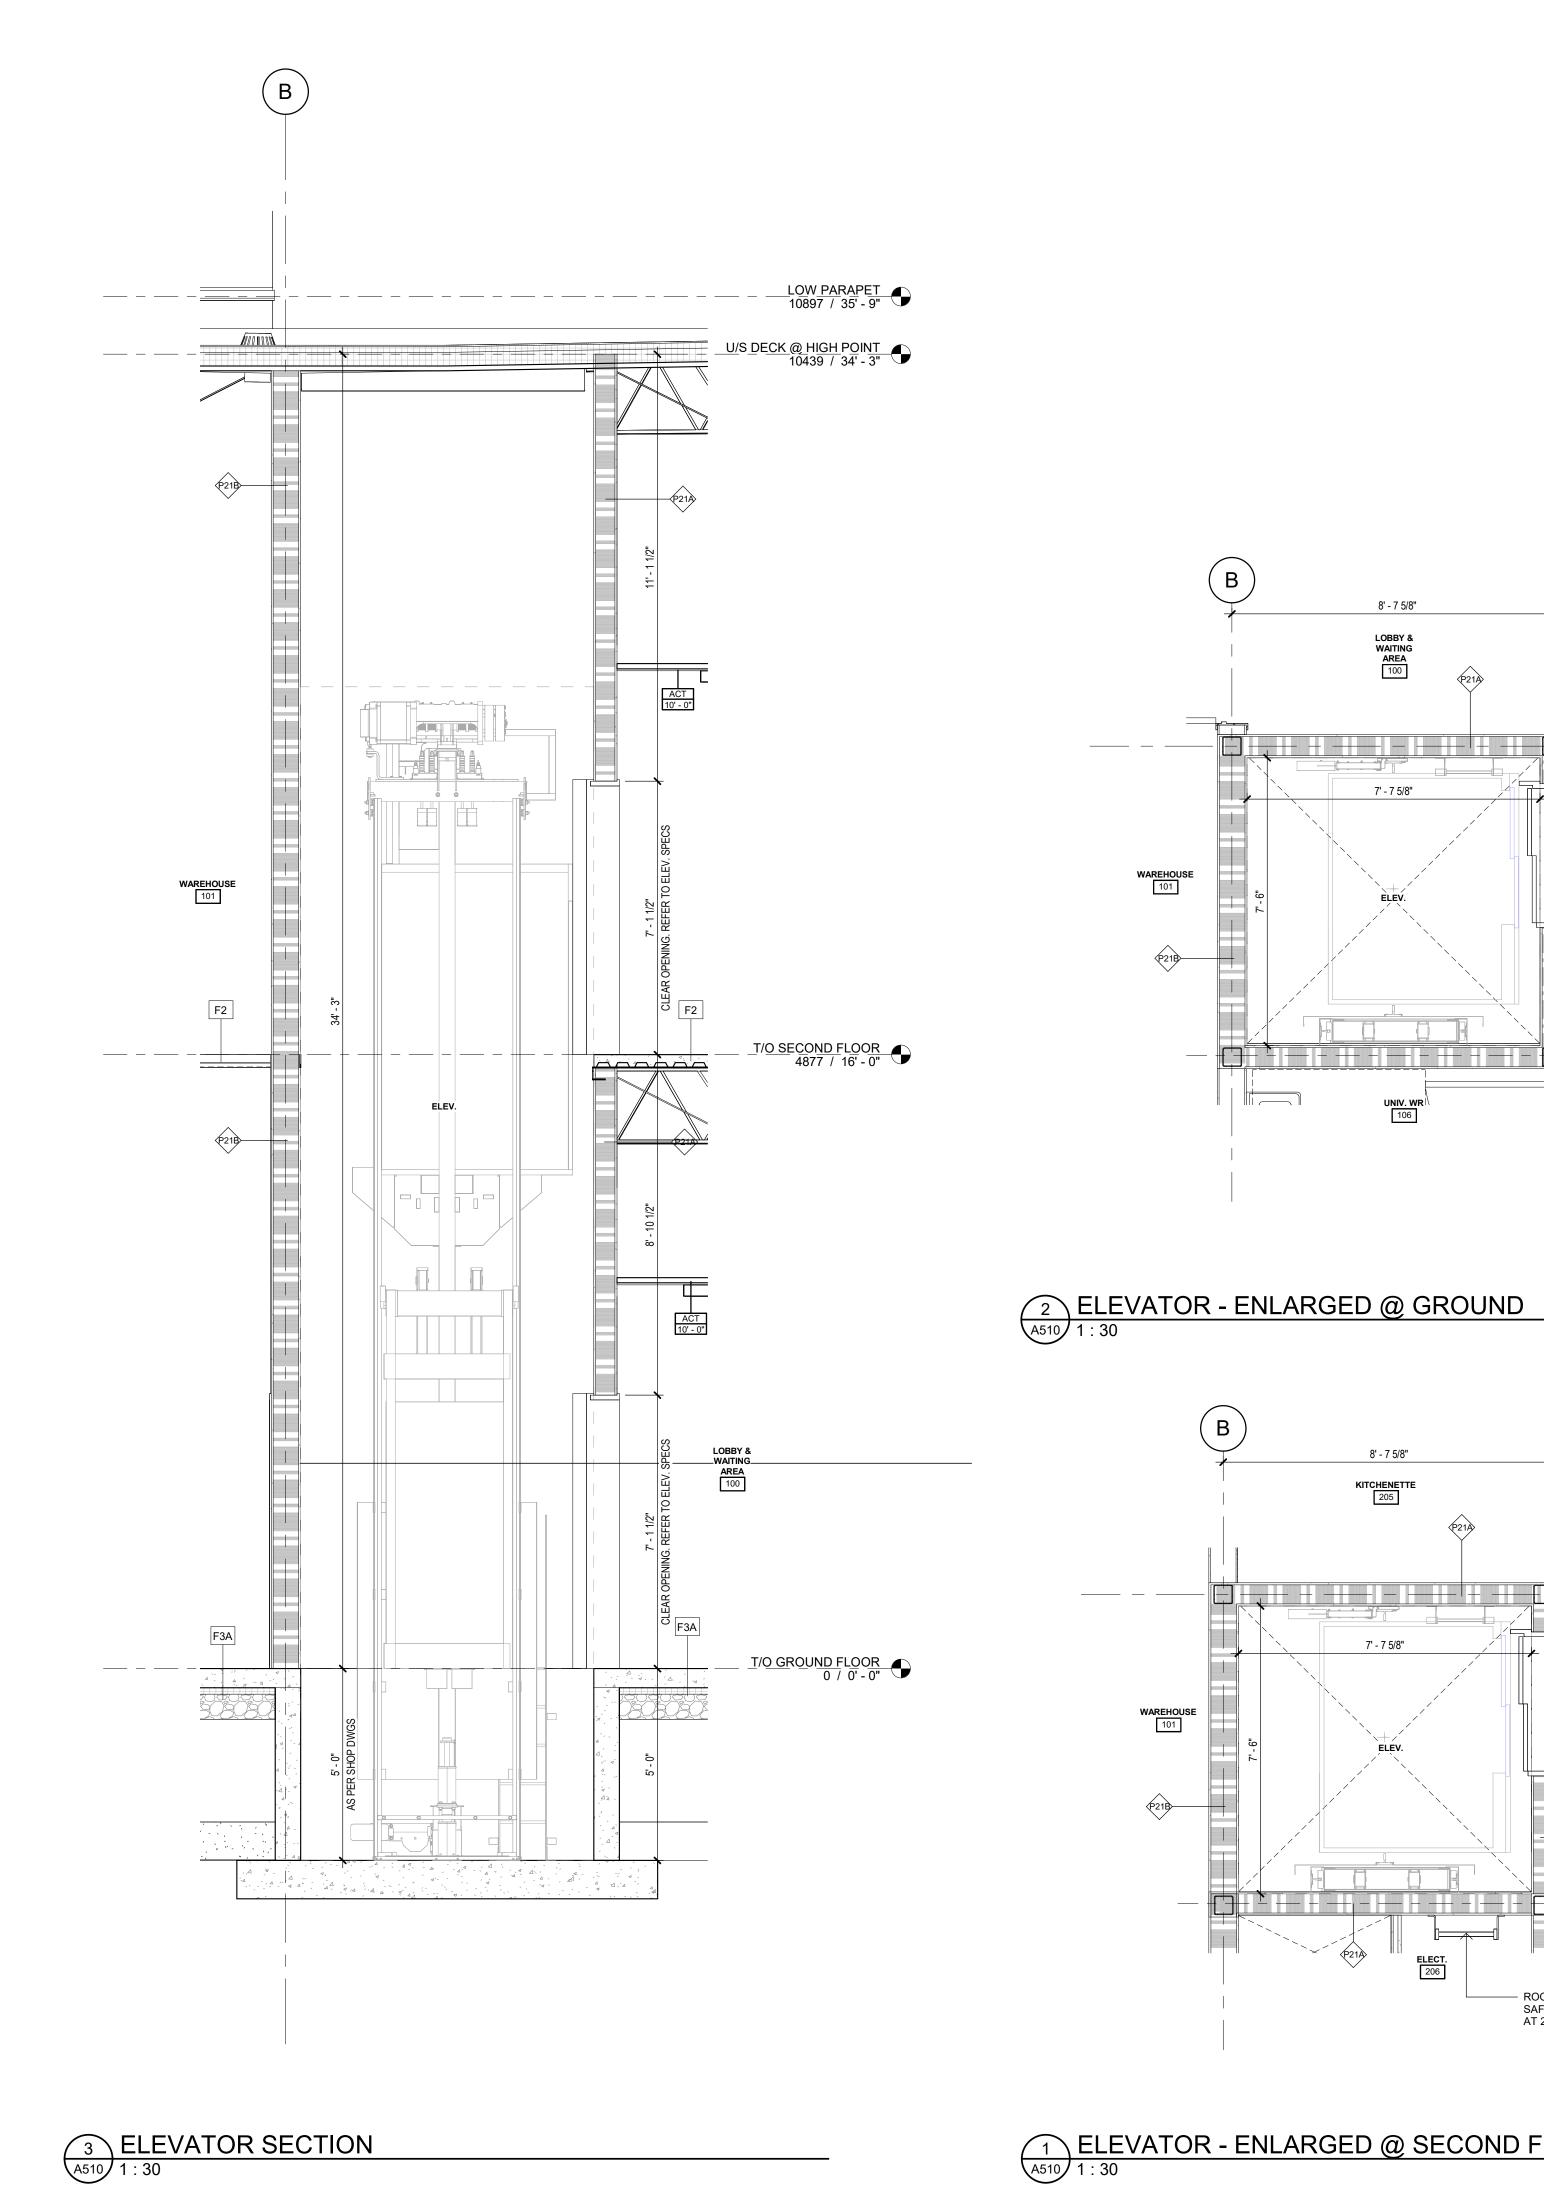



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CONFIRM ELEVATOR AND SIZE

1 NZ CLIENT REVIEW 24-07-10 Date YY-MM-DD ISSUANCE SCHEDULE

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CONSULTANTS

DEVELOPMENT CONSULTANT: API

API CONSULTANTS INC. 1464 CORNWALL ROAD, UNIT 7 OAKVILLE, ONTARIO L6J 7W5 P: 905.337.7249

ARCHITECT:

SAPLYS ARCHITECTS INC. 1464 CORNWALL ROAD, UNIT 8 OAKVILLE, ONTARIO L6J 7W5

CLIENT:

2

ROOF ACCESS LADDER W/ SAFETY CAGE STARTING AT 2.2M ABOVE LEVEL

STARNIGHT IMPORT & EXPORT 35B IRONSIDE CRESCENT SCARBOROUGH, ON M1X 1G5 ST R



WAREHOUSE & OFFICE **HEADQUARTERS**

45 BLOWERS CRES AJAX, ON L1Z 0N4

DRAWING TITLE ELEVATOR PLAN, **SECTION & DETAILS**

BY CHECK ISSUED FOR AGR NZ CLIENT REVIEW
PROJECT NO.: SHEET NO.:
A22-018

SCALE: As indicated ISSUE DATE: **24-07-10**

© SAPLYS ARCHITECTS INC.

1 ELEVATOR - ENLARGED @ SECOND FLOOR
A510 1:30

8' - 7 5/8"


LOBBY & WAITING AREA


8' - 7 5/8"


KITCHENETTE 205

7' - 7 5/8"

LOBBY & WAITING AREA

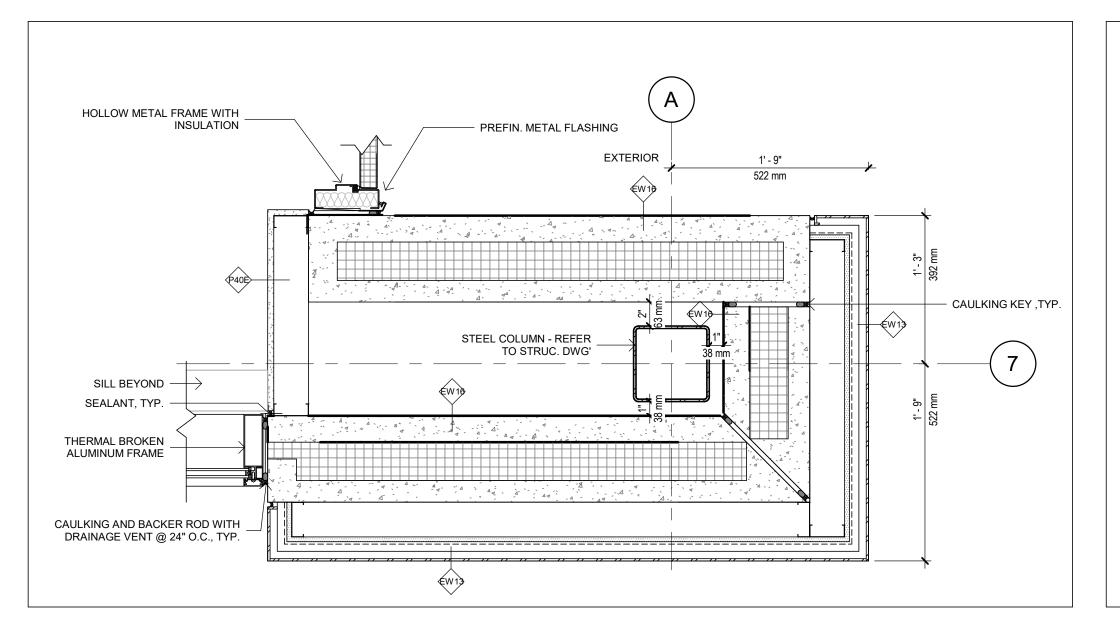


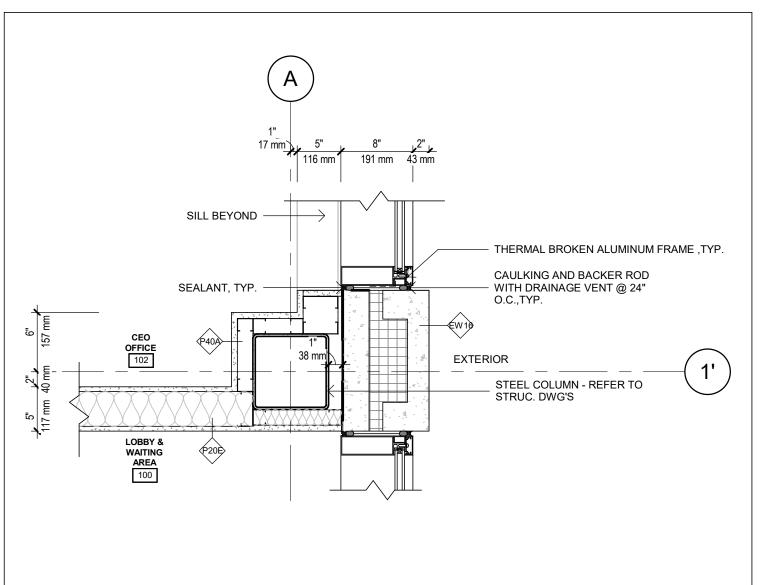

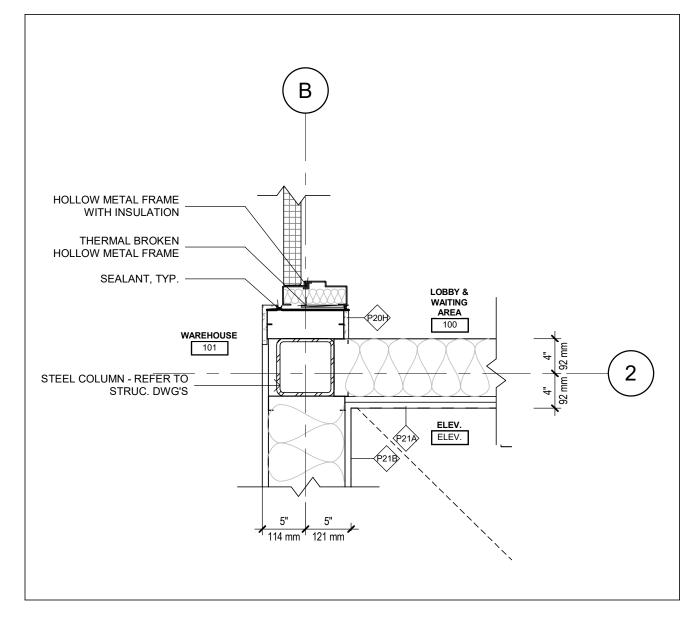





8 PLAN DETAIL@ EXIT FROM OFFICE A520 1:10

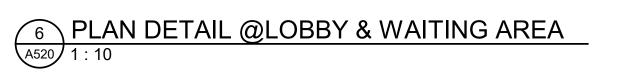



3 PLAN DETAIL @ELEVATOR
A520 1:10

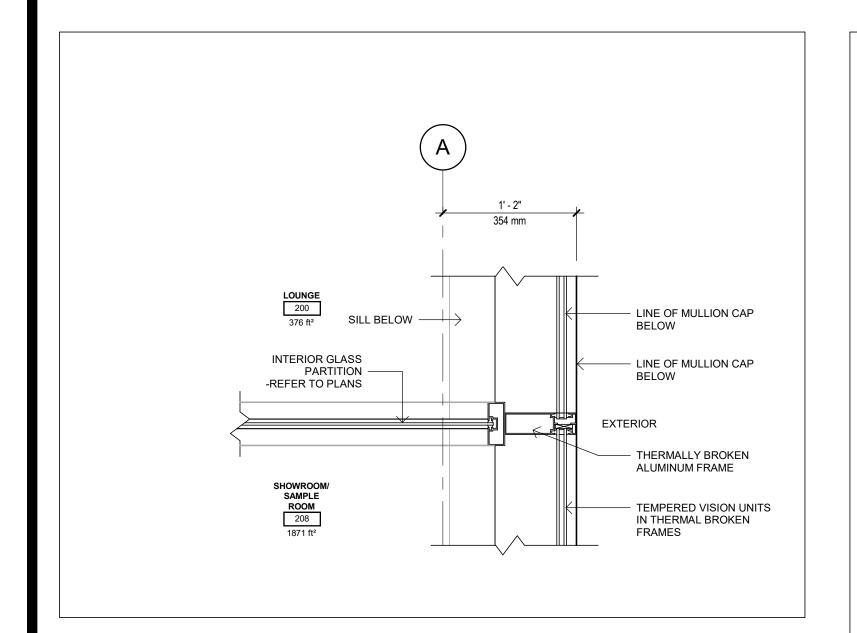

9 PLAN DETAIL@ SECOND FLOOR
A520 1:10

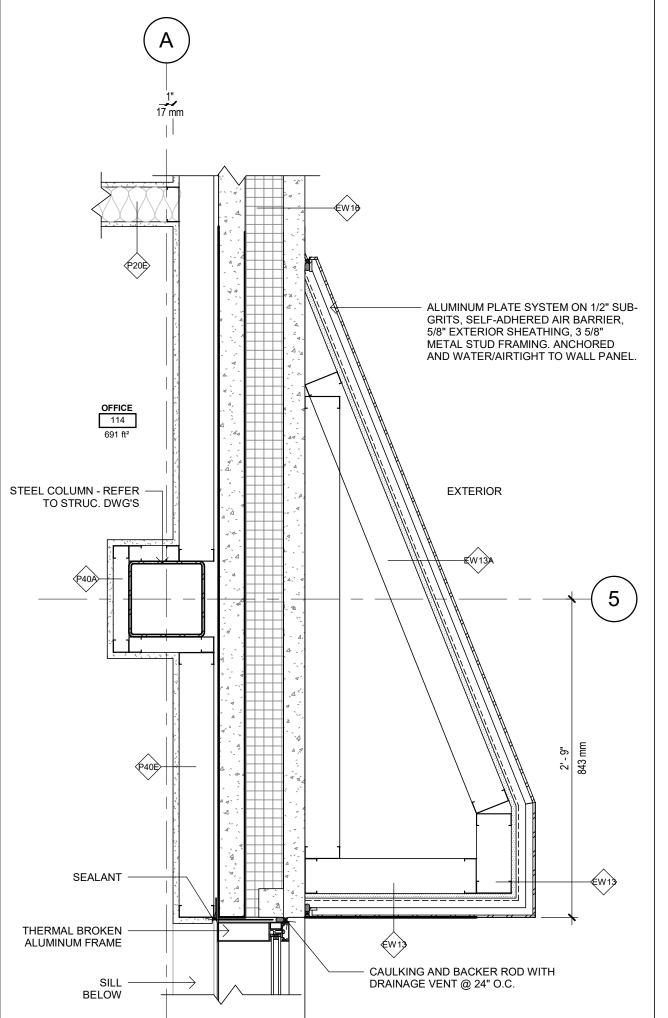

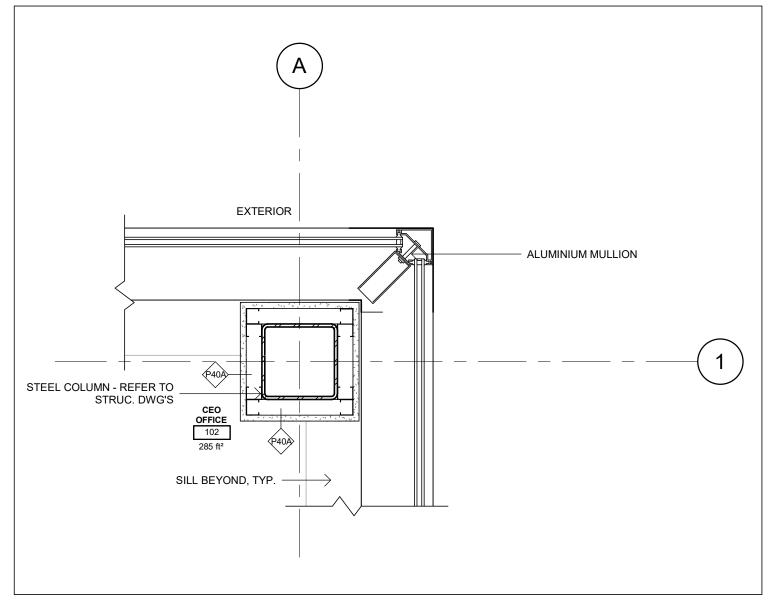


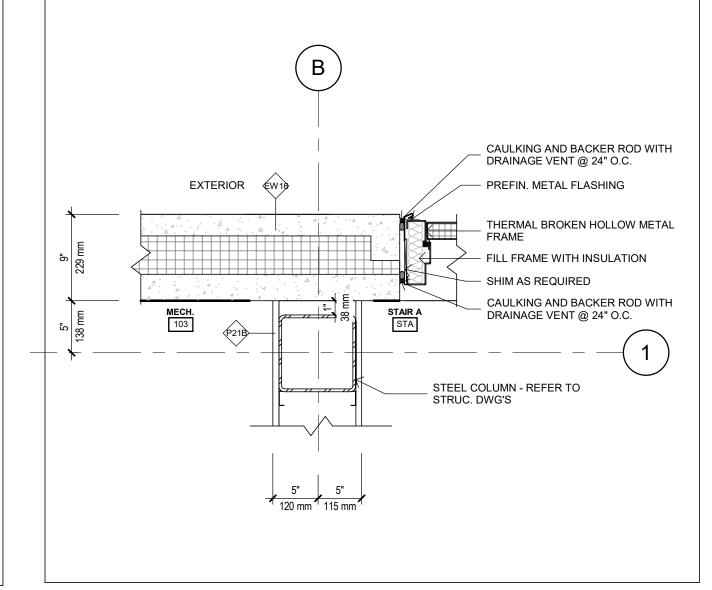





5 PLAN DETAIL @CEO OFFICE A520 1:10




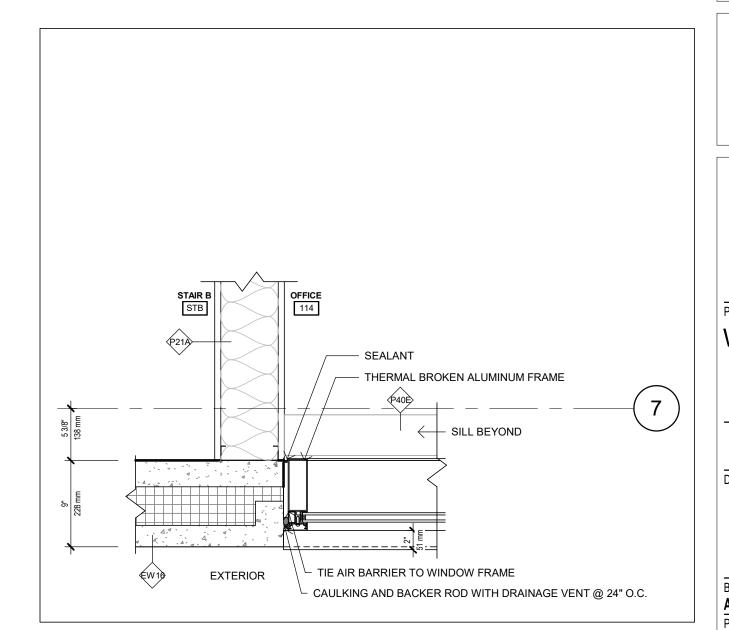

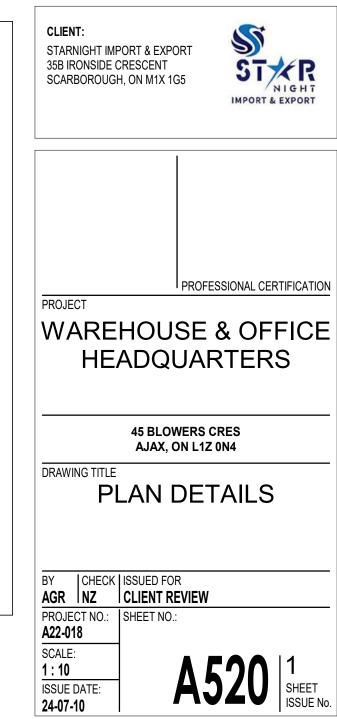


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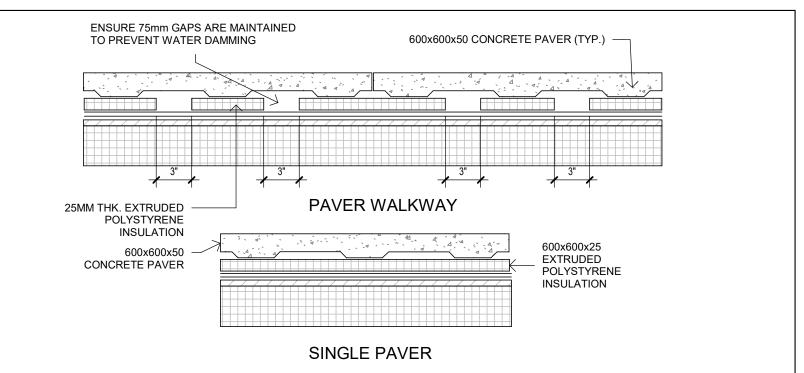


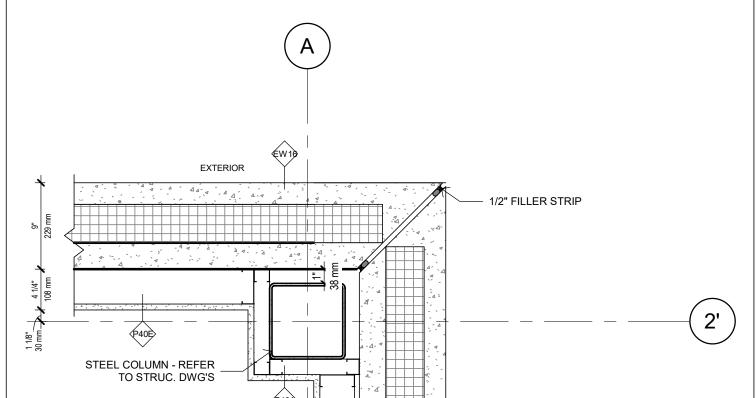

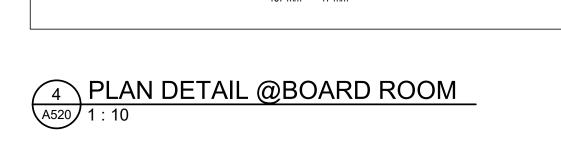



1 PLAN DETAIL @STAIRCASE B A520 1:10



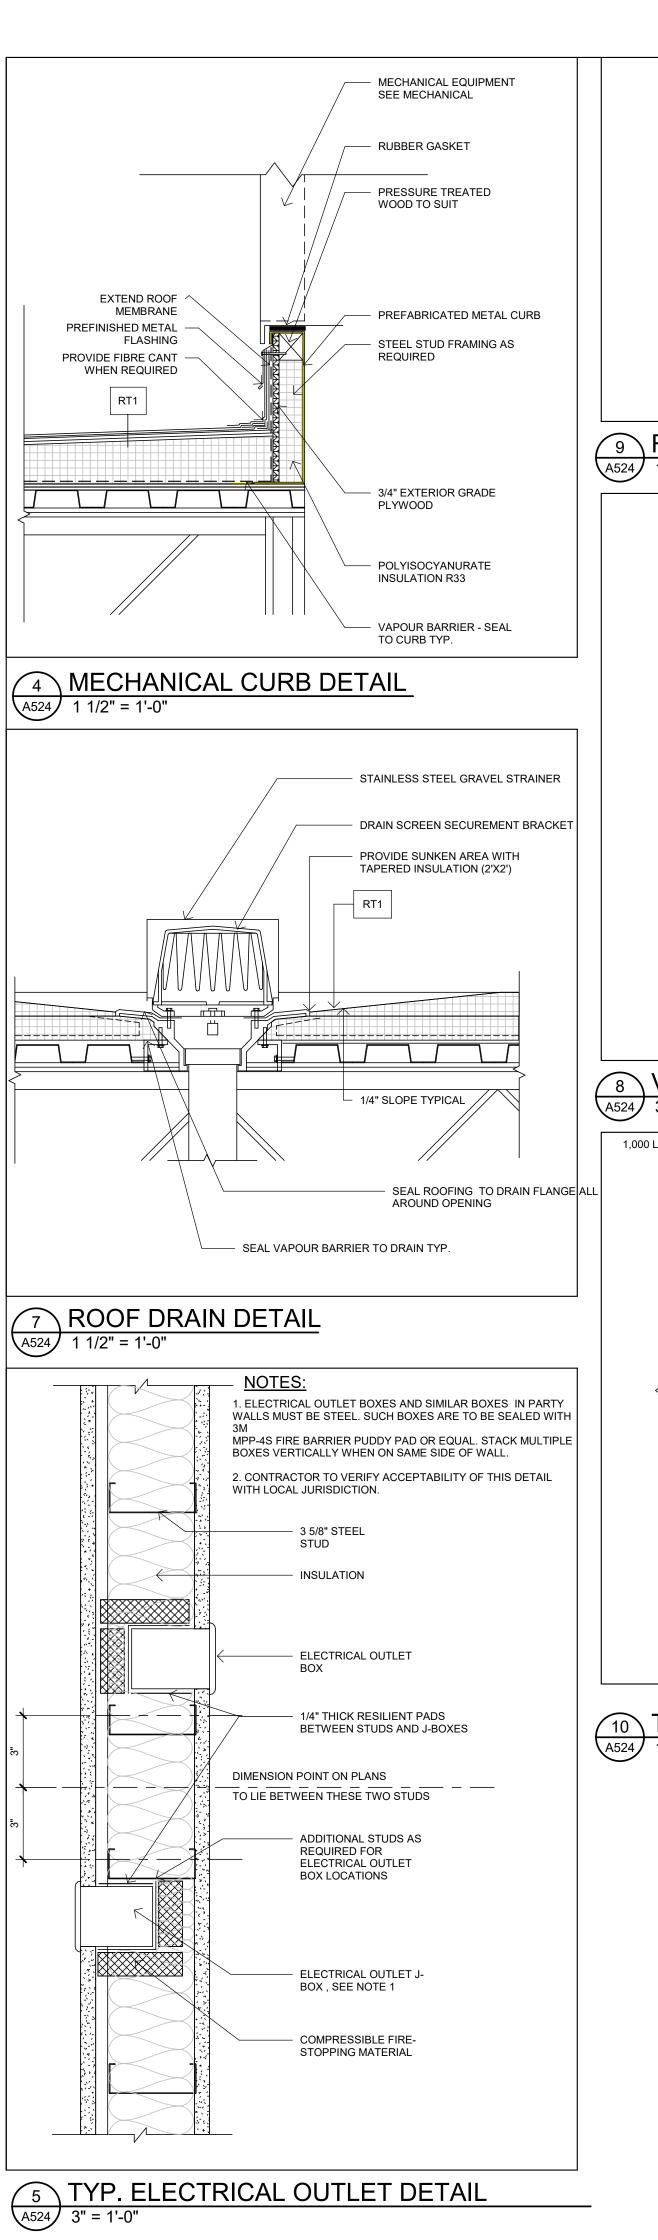


9 ROOF PAVER WALKWAY DETAIL A524 1 1/2" = 1'-0"

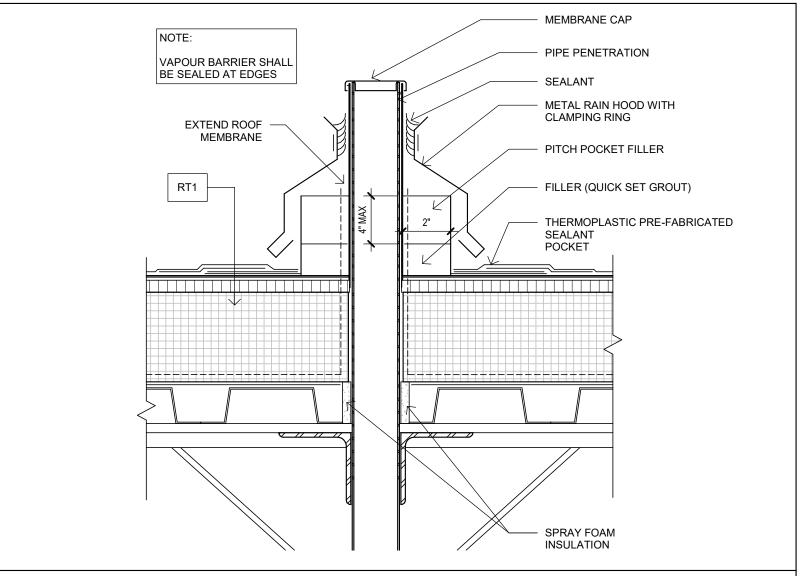

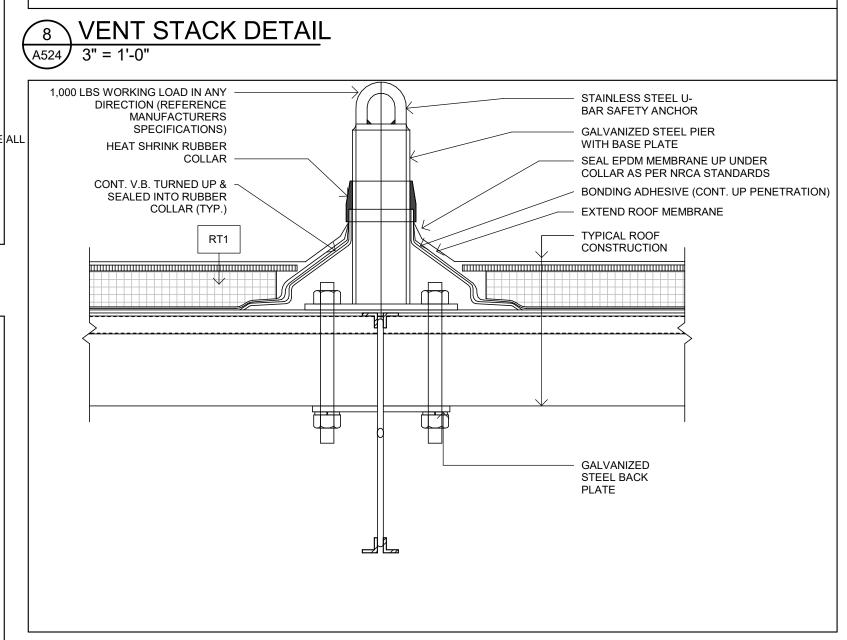


TYPICAL ROOF ANCHOR DETAIL

A524 1 1/2" = 1'-0"

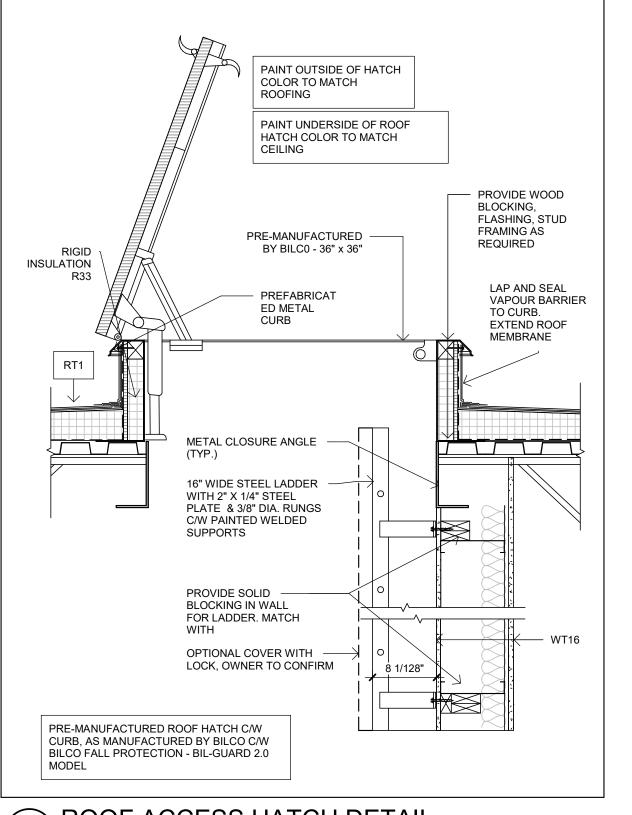


NOT ISSUED FOR CONSTRUCTION


ROOF ACCESS HATCH DETAIL A524 1" = 1'-0"

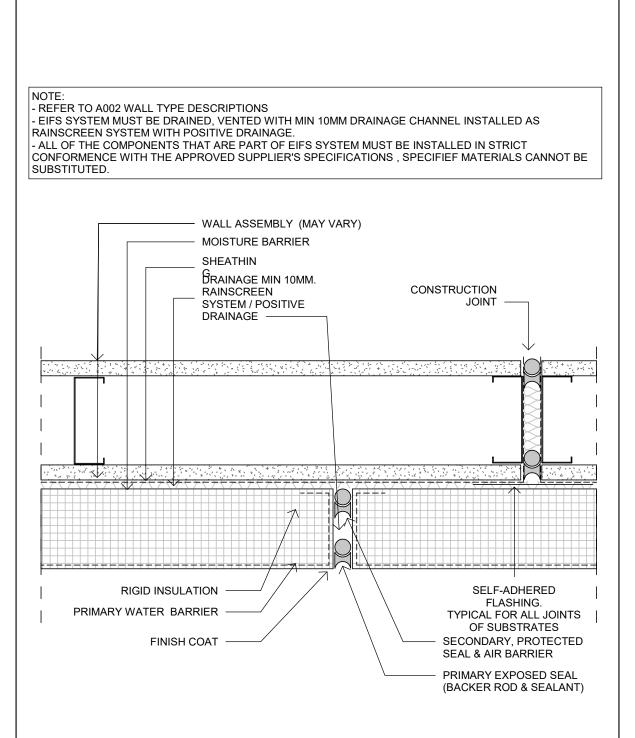

11 TYPICAL EIFS JOINT
A524 3" = 1'-0"

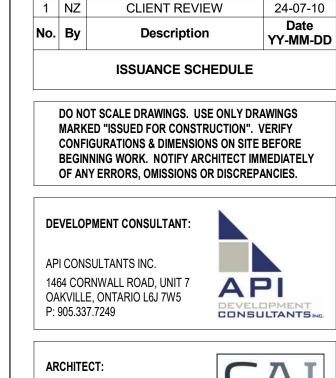



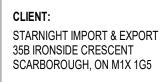





WAREHOUSE & OFFICE **HEADQUARTERS**

45 BLOWERS CRES AJAX, ON L1Z 0N4 STANDARD / TYPICAL **DETAILS**

BY CHECK ISSUED FOR AGR NZ CLIENT REVIEW PROJECT NO.: SHEET NO.: A22-018 SCALE: As indicated


ISSUE DATE:

24-07-10

- ALL PENETRATIONS TO BE FULLY SEALED. PROVIDE SUFFICIENT THERMAL BREAKING AS PER SB-10 TABLE - COORDINATE WITH OBC MATRIX, SB-10 TABLE, AND OTHER DRAWINGS FOR CONFORMITY

- STANDARD DETAILS ARE PROPOSED FOR GENERAL INTENT ONLY; DETAILING MAY VARY

BASED ON MANUF. / TRADES' SPECS & STANDARDS. PROVIDE SHOP DRAWINGS WITH SUFFICIENT DETAILING & DOCUMENTATION.

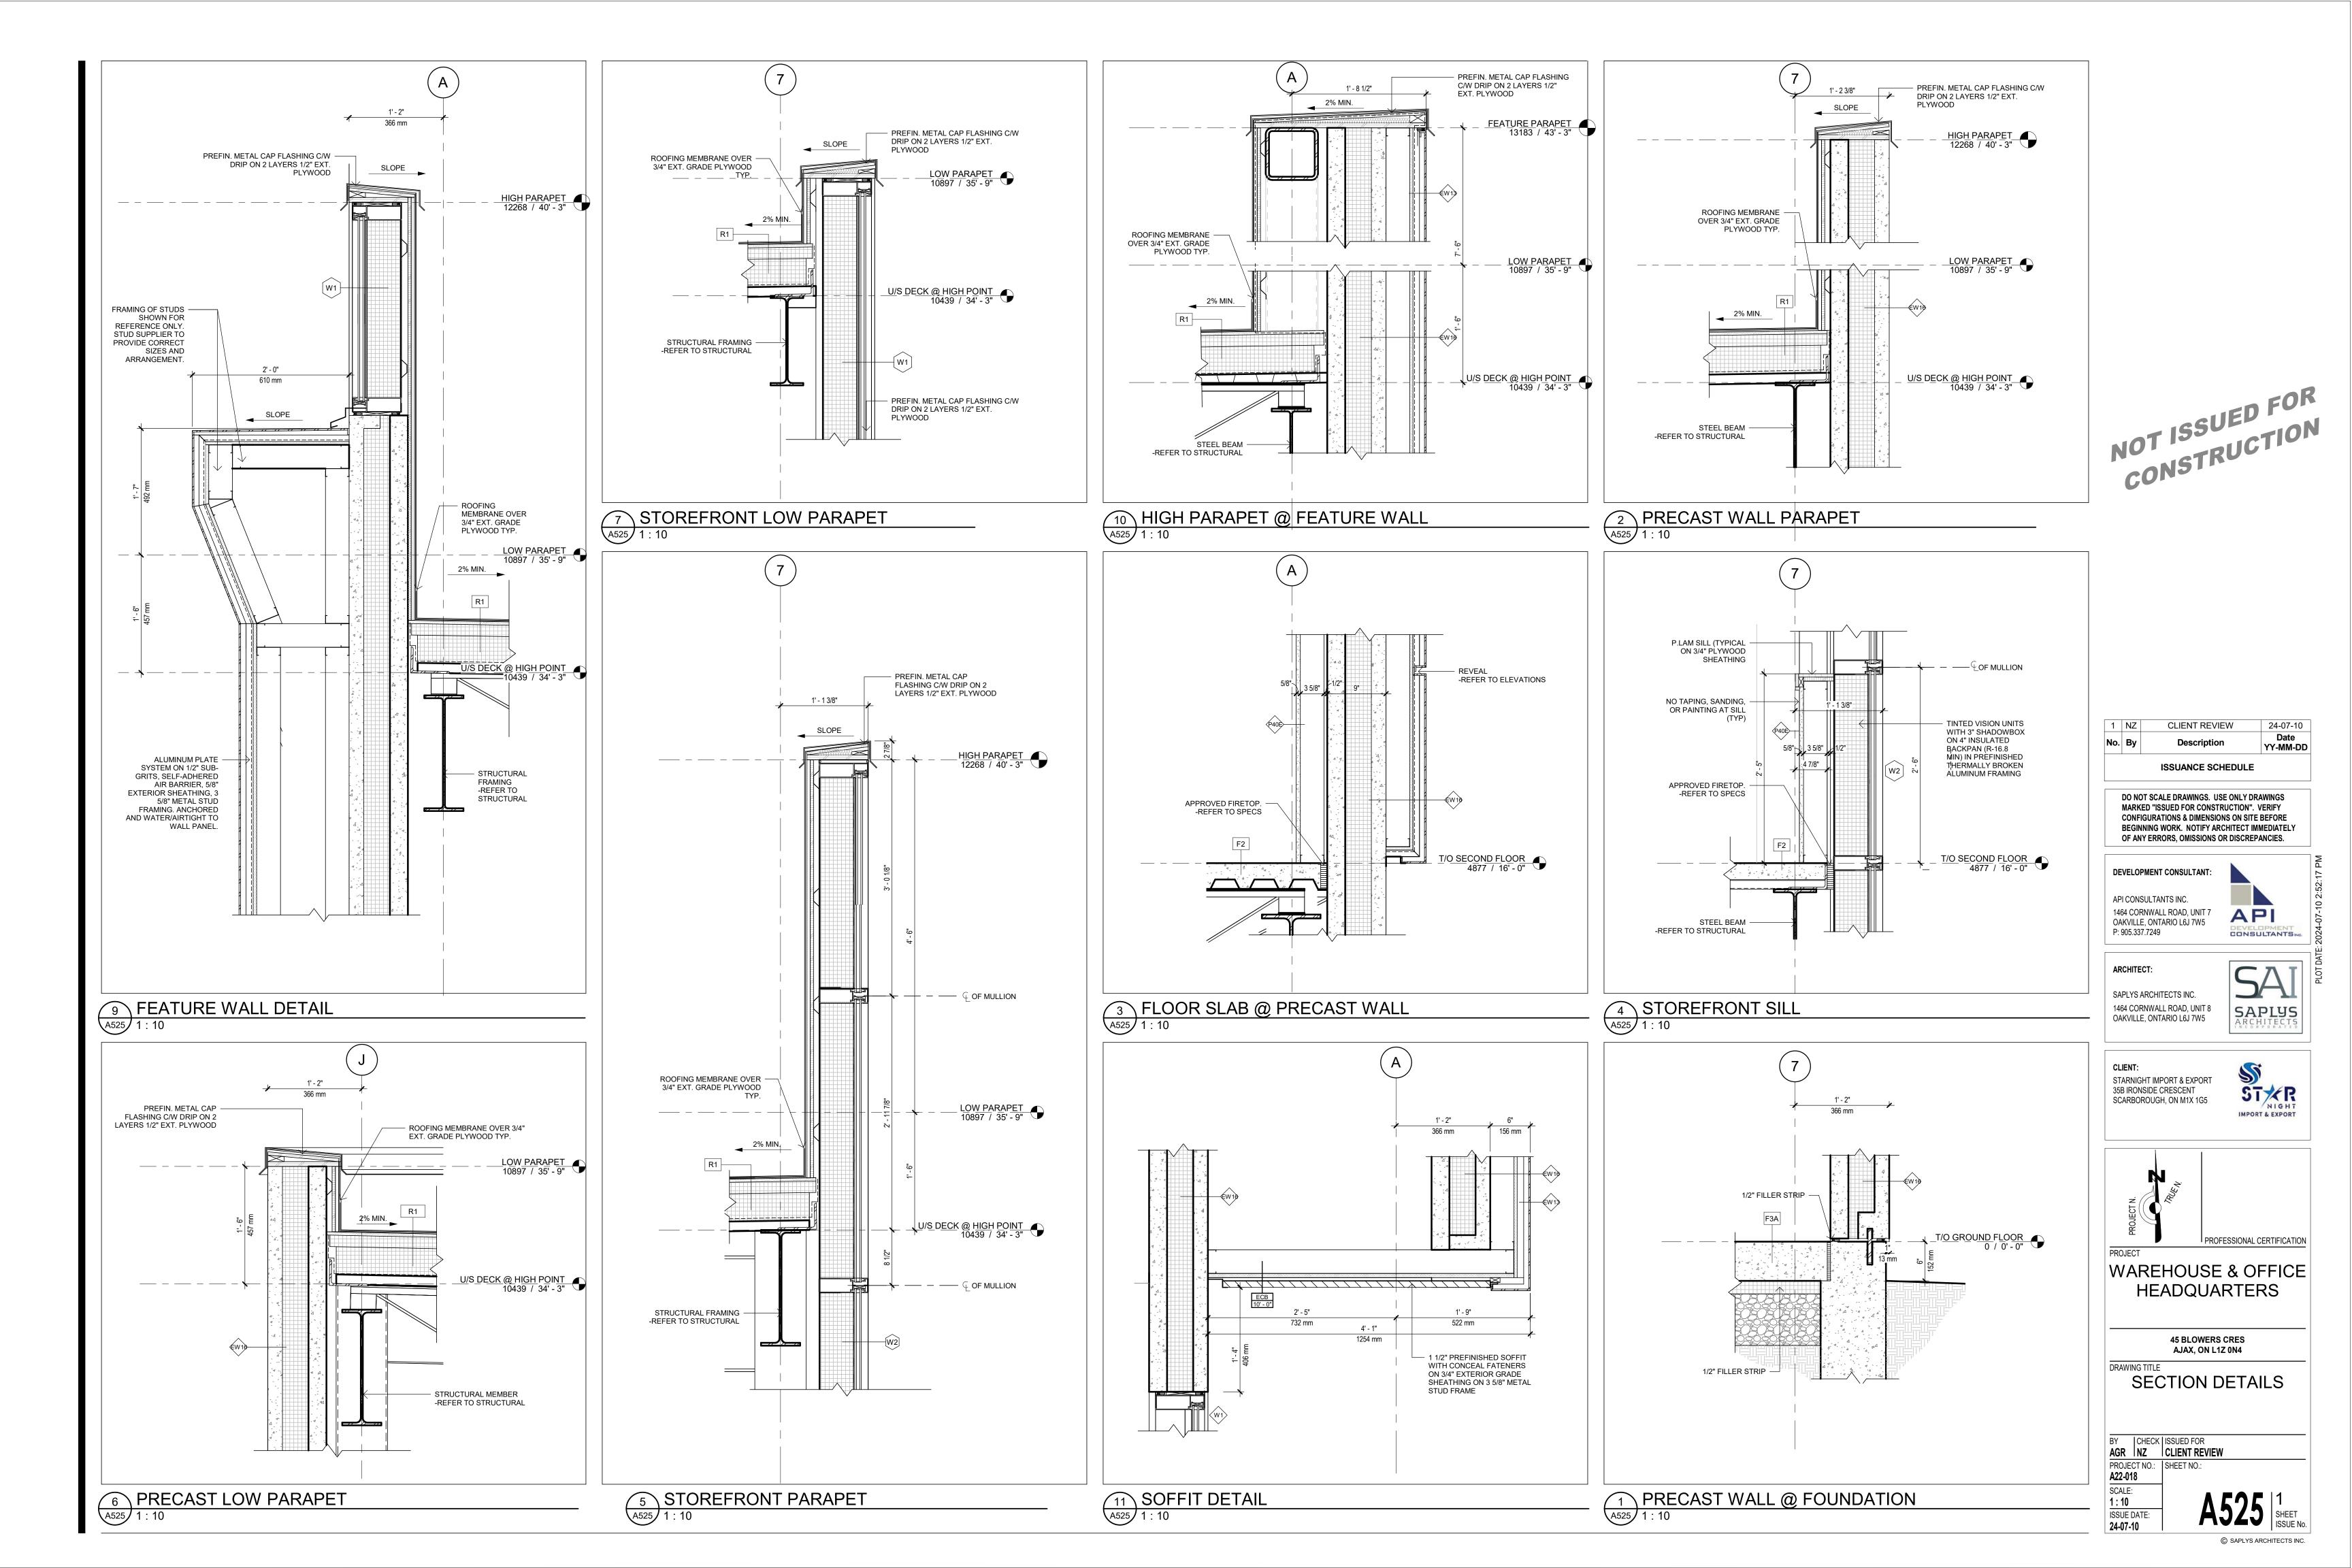

HARDWARE SCHEDULE SET #2 WAREHOUSE TO OFFICE SET #3 INTERIOR STAIR DOOR SET #3B EXTERIOR EGRESS DOOR STORAGE / ELECT / JAN. <u>SET #5</u> EXTERIOR ELECTRICAL / VESTIBULE DOOR INTERIOR VESTIBULE 6 HINGES <u>MECHANICAL</u> 1 FIRE RATING LABEL 1 LOCKSET 1 LOCKSET 1 CLOSER 1 CLOSER 6 HINGES 3 HINGES 1 CLOSER 2 CLOSER 2 CLOSER 1 CLOSER 1 EXIT DEVICE 1 FLOOR STOP 1 FLUSH BOLTS 1 POWER OPERATOR 1 KICK PLATE 1 SMOKE SEAL 1 POWER OPERATOR 1 SMOKE SEAL 1 THRESHOLD 1 LOCKSET 2 FLUSH BOLTS 2 FLUSH BOLTS 1 THRESHOLD 1 FLOOR STOP 1 WEATHER STRIPPING 1 CLOSER 2 PUSH BAR (HORIZONTAL) 2 PUSH BAR (HORIZONTAL) 1 DOOR SWEEP 1 SMOKE SEAL 1 RAIN DRIP CAP 1 WEATHER STRIPPING 2 PULL BAR (VERTICAL) 2 PULL BAR (VERTICAL) 2 KICKPLATE 1 EXIT DEVICE 1 THRESHOLD 1 THRESHOLD 2 DOOR SWEEP 2 DOOR SWEEP 1 WEATHER STRIPPING **EXTERIOR GARBAGE** OFFICE / WASHROOM **UNIVERSAL WASHROOM BOARD ROOM / OFFICE** ROOM / WAREHOUSE 3 HINGES 3 HINGES 3 HINGES 1 CLOSER 1 PRIVACY SET 1 PRIVACY SET **EXTERIOR** 1 CLOSER 1 CLOSER 1 KICKPLATE 6 HINGES 2 FLUSH BOLTS 1 FLOOR STOP 1 FLOOR STOP 1 WALL STOP 3 SILENCERS 1 DOOR SEAL 1 LEVER TYPE HANDLE 1 DUST PROOF STRIKE 1 LATCHGUARD 3 SILENCERS 1 UNIVERSAL WASHROOM HARDWARE PACKAGE INCL. 1 LOCKSET 1 CLOSER POWER DOOR OPERATOR, 1 ASTRAGAL SET PUSH TO LOCK & PUSH 1 THRESHOLD BUTTON ACCESS. 2 DOOR SWEEP 1 WEATHER STRIPPING **DOOR TYPES** - REFER TO SCHEDULE - CLEAR TEMPERED -FOR OCCURRENCE GLASS OF VISION LITES С C-1 OVERHEAD SECTIONAL FULL GLASS INTERIOR DOUBLE HOLLOW ALUMINUM WIDE STILE ALUMINUM WIDE STILE SOLID CORE **HOLLOW METAL**

STOREFRONT-

EXTERIOR

VARIES VARIES,2"

INTERIOR DOOR. REFER

TO SCHEDULE

DOUBLE STOREFRONT-

EXTERIOR


DOOR DRIVE-IN -


EXTERIOR


METAL PAINTED

							DOOK SO	PUEDOFE					
		DOOR						FRAME					
MARK	DOOR LOCATION	DOOR TYPE	II	HEIGHT	THICKNESS	DOOR MATERIAL	DOOR FINISH	FRAME TYPE	FRAME MATERIAL	FRAME FINISH	FIRE RATING	HARDWARE SET	COMMENTS
GROUND F	LOOR												
100A	MAIN VEST		6' - 0"	7' - 0"	0' - 1 3/4"	ALUM./GLASS	CLEAR ANODIZED	В	ALUMINUM	PREFINISHED		1	
100B	MAIN VEST	C-1	6' - 0"	7' - 0"	0' - 1 3/4"	ALUM./GLASS	CLEAR ANODIZED	В	ALUMINUM	PREFINISHED		1B	
101A	WAREHOUSE/OFFICE DW	В	3' - 2"	7' - 0"	0' - 1 3/4"	НМ	PAINTED	Α	НМ	PAINTED		2	
101B	WAREHOUSE	В	3' - 2"	7' - 0"	0' - 1 3/4"	GALV. HM	PAINTED	Α	HM	PAINTED		3B	
101C	WAREHOUSE	В	3' - 2"	7' - 0"	0' - 1 3/4"	GALV. HM	PAINTED	Α	HM	PAINTED		3B	
101D	WAREHOUSE	B-1	6' - 0"	7' - 0"	0' - 1 3/4"	GALV. HM	PAINTED	Α	HM	PAINTED		6	
101E	WAREHOUSE/OFFICE DW	В	3' - 2"	7' - 0"	0' - 1 3/4"	HM	PAINTED	Α		PAINTED		2	
102	CEO OFFICE	С	3' - 0"	7' - 0"	0' - 1 3/4"	ALUM./GLASS	CLEAR ANODIZED	С	ALUMINUM	CLEAR ANODIZED		7	
02A	JAN	В	3' - 2"	7' - 0"	0' - 1 3/4"	SWC/HM	PAINTED	A	HM	PAINTED		4	
103	MECH.	В	3' - 2"	7' - 0"	0' - 1 3/4"	GALV. HM	PAINTED	Α	НМ	PAINTED		5	
104	ELECT.	В	3' - 2"	7' - 0"	0' - 1 3/4"	GALV. HM	PAINTED	Α	НМ	PAINTED		5	
105	GARBAGE	B-1	6' - 0"	7' - 0"	0' - 1 3/4"	GALV. HM	PAINTED	В	НМ	PAINTED		6	
106	UNIV. WR	Α	3' - 2"	7' - 0"	0' - 1 3/4"	НМ	PAINTED	Α	НМ	PAINTED		8	
107	UNISEX WR	Α	3' - 0"	7' - 0"	0' - 1 3/4"	HM	PAINTED	Α	НМ	PAINTED		7	
108A	SECURITY OFFICE	В	3' - 0"	7' - 0"	0' - 1 3/4"	НМ	PAINTED	Α	НМ	PAINTED		2	
108B	SECURITY OFFICE	В	3' - 0"	7' - 0"	0' - 1 3/4"	НМ	PAINTED	Α	НМ	PAINTED		2	
109	STORAGE	Α	3' - 0"	7' - 0"	0' - 1 3/4"	НМ	PAINTED	Α	НМ	PAINTED		4	
112	UNISEX WR 112	Α	3' - 2"	7' - 0"	0' - 1 3/4"	SCW/HM	PAINTED	Α	НМ	PAINTED		7	
113	UNISEX WR 113	Α	3' - 2"	7' - 0"	0' - 1 3/4"	SCW/HM	PAINTED	Α	НМ	PAINTED		7	
114	OFFICE EXT.	С	3' - 2"	4' - 3"	0' - 1 3/4"	ALUM./GLASS	CLEAR ANODIZED	D	ALUMINUM	PREFINISHED		3B	
115	DIRECTOR 115	С	3' - 0"	7' - 0"	0' - 1 3/4"	ALUM./GLASS	CLEAR ANODIZED	С		CLEAR ANODIZED		7	
116	DIRECTOR 116	С	3' - 0"	7' - 0"	0' - 1 3/4"	ALUM./GLASS	CLEAR ANODIZED	С		CLEAR ANODIZED		7	
117	BOARD ROOM	С	3' - 1 1/2"	7' - 0"	0' - 1 3/4"	ALUM./GLASS	CLEAR ANODIZED	С	ALUMINUM	CLEAR ANODIZED		7B	
212	CORRIDOR 118	С	3' - 0"	7' - 0"	0' - 1 3/4"	ALUM./GLASS		С	ALUMINUM	CLEAR ANODIZED		7B	
DH1	WAREHOUSE	D	8' - 0"	10' - 0"	0' - 1 187/256"								
OH2	WAREHOUSE	D	8' - 0"		0' - 1 187/256"								
OH3	WAREHOUSE	D	8' - 0"	10' - 0"	0' - 1 187/256"								
SECOND F		1	1	1	1		1	1	1	1	1	1	
201	OFFICE 201	С	3' - 0"	7' - 0"	0' - 1 3/4"	ALUM./GLASS	CLEAR ANODIZED	С		CLEAR ANODIZED		7	
202	OFFICE 202	С	3' - 0"	7' - 0"	0' - 1 3/4"	ALUM./GLASS		С		CLEAR ANODIZED		7	
203	OFFICE 203	С	3' - 0"	7' - 0"	0' - 1 3/4"	ALUM./GLASS	CLEAR ANODIZED	С	ALUMINUM	CLEAR ANODIZED		7	
204	STORAGE	Α	3' - 0"	7' - 0"	0' - 1 3/4"	НМ	PAINTED	Α	НМ	PAINTED		4	
206	ELECTRICAL	В	3' - 2"	7' - 0"	0' - 1 3/4"	НМ	PAINTED	Α		PAINTED		4	
207	WASHROOM	Α		7' - 0"	0' - 1 3/4"	НМ	PAINTED	Α		PAINTED		7	
208	SHOWROOM/ SAMPLE ROOM	С	6' - 0"	7' - 0"	0' - 1 3/4"	ALUM./GLASS	CLEAR ANODIZED	В	ALUMINUM	CLEAR ANODIZED		7B	
STAIRS													
STA1	STAIR A	В	3' - 2"	7' - 0"	0' - 1 3/4"	НМ	PAINTED	Α			45 MIN.	3	
STA2	STAIR A	В	3' - 2"	7' - 0"	0' - 1 3/4"	НМ	PAINTED	Α		PAINTED	45 MIN.	3	
STAX	STAIR A	В		7' - 0"	0' - 1 3/4"	GALV. HM	PAINTED	Α		PAINTED		3B	
STB1	STAIR B	В		7' - 0"	0' - 1 3/4"	НМ	PAINTED	Α		PAINTED	45 MIN.	3	
STB2	STAIR B	В		7' - 0"	0' - 1 3/4"	HM	PAINTED	Α		PAINTED	45 MIN.	3	
STBX	STAIR B	В	3' - 2"	7' - 0"	0' - 1 3/4"	GALV. HM	PAINTED	Α	HM	PAINTED		3B	

DOOR SCHEDULE

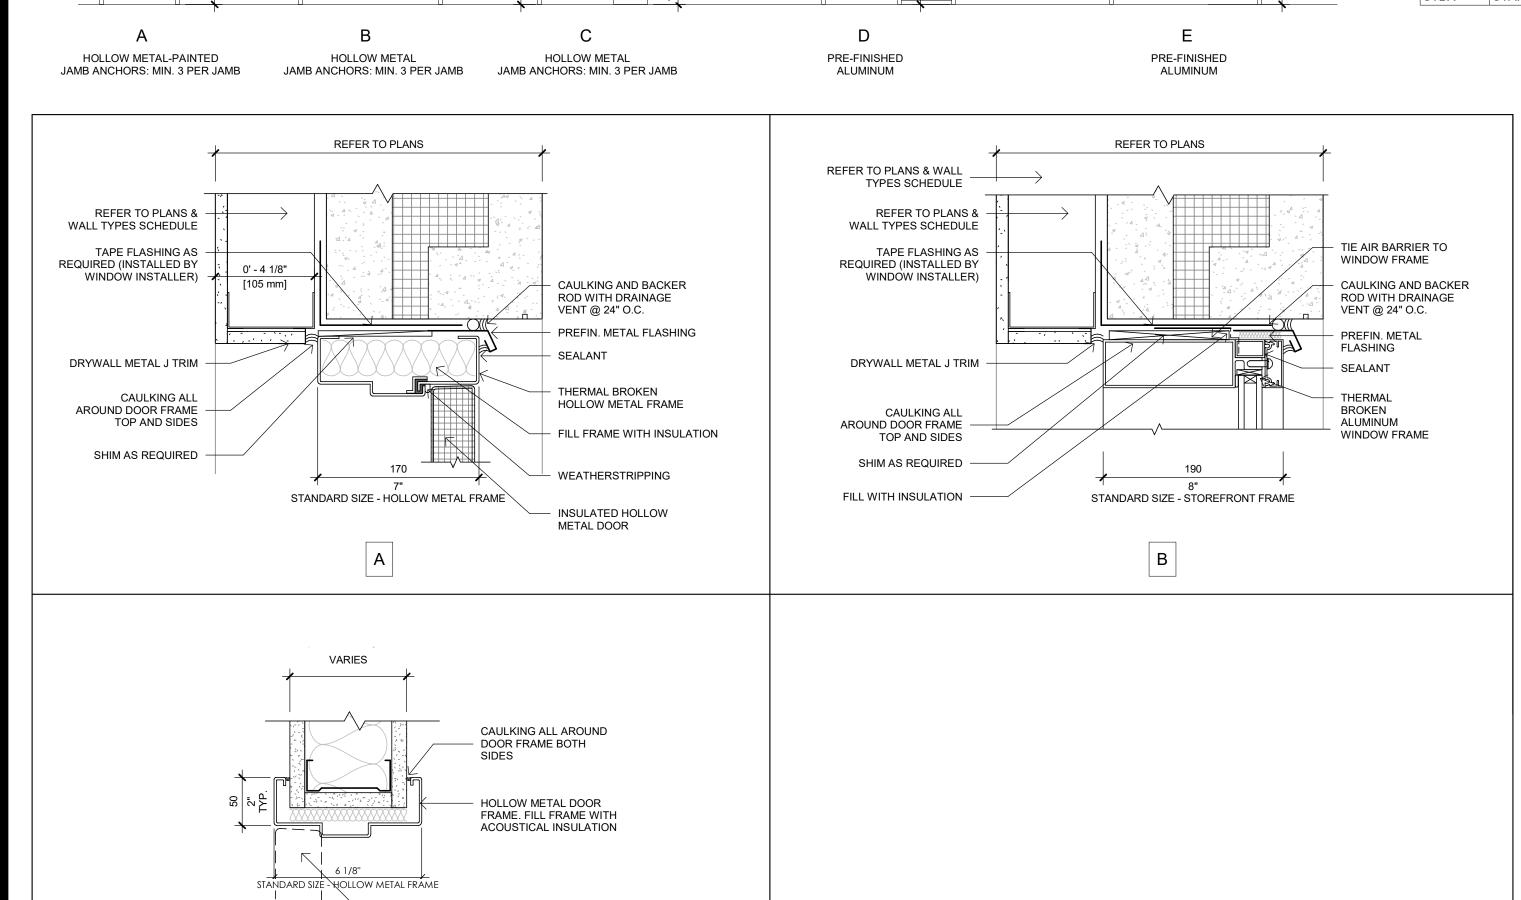

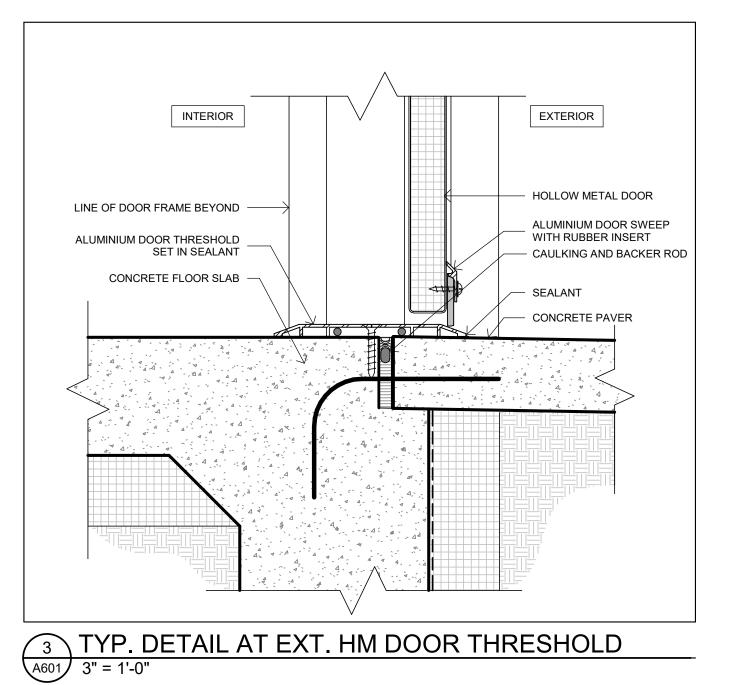

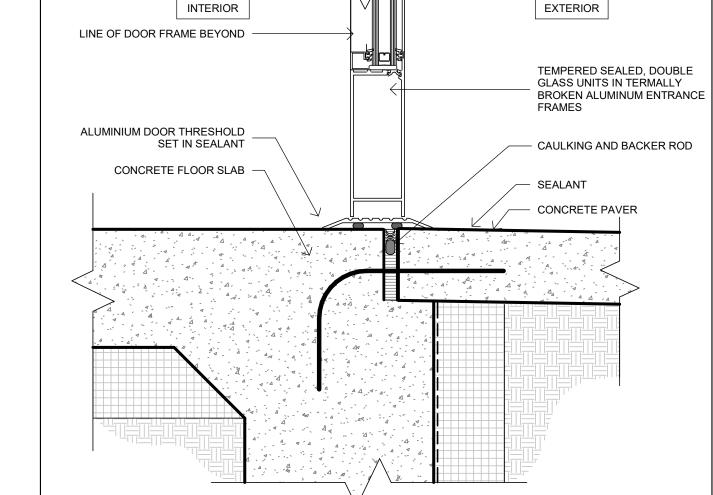

TYP. DETAIL AT EXT. STOREFRONT THRESHOLD

3" = 1'-0"

- DOOR STANDARD DETAILS ARE PROPOSED FOR GENERAL INTENT ONLY; DETAILING MAY VARY BASED ON MANUF. / TRADES' SPECS & STANDARDS. PROVIDE SHOP DRAWINGS WITH SUFFICIENT DETAILING & DOCUMENTATION. - COORDINATE WITH OBC MATRIX, SB-10 TABLE,

CONFORMITY

DOOR SCHEDULE AND OTHER DRAWINGS FOR

DOOR SCHEDULE NOTES

REFER TO FLOOR PLANS FOR DOOR SWING AND "ACTIVE" DOOR LOCATIONS. ACTIVE LEAF TO COMPLY WITH OBC 3.8.3.3.

REFER TO ELEVATIONS AND MATERIAL SCHEDULES FOR EXTERIOR COLOURS AND

FINISHES. EXTERIOR DOORS AND FRAMES MUST BE

THERMALLY BROKEN AND INSULATED. DOOR, FRAME, AND HARDWARE SCHEUDULES

MUST BE SUBMITTED FOR REVIEW PRIOR TO ORDERING OR FABRICATION.

ALL WELDED CONSTRUCTION AT HOLLOW METAL DOOR FRAMES.

PROVIDE REMOTE CARD READERS AT ALL EXTERIOR ENTRANCE DOORS.

PROVIDE DOOR VIEWER (OUTSIDE LOOKING INTO THE ROOM). MOUNTED AT 4'-11" (3'-11" FOR ACC.) ABOVE FINISH FLOOR AT MEETING

8. ALL FIRE RATED DOOR TO HAVE CLOSERS AND LATCHING HARDWARE.

PANIC EXIT HARDWARE REQUIRED. 10. PER OBC 3.8.3.3(15), APPLY MIN 50MM WIDE VISION STRIP AT 1350MM TO 1500MM HORIZONTALLY ABOVE FINISHED FLOOR LEVEL IN COLOUR AND BRIGHTNESS CONTRASTED TO THE BACKGROUND OF THE DOOR FOR ALL GLAZED DOORS IN BARRIER FREE PATH OF

NOT ISSUED FOR CONSTRUCTION

1 NZ CLIENT REVIEW 24-07-10 YY-MM-DD **ISSUANCE SCHEDULE**

DO NOT SCALE DRAWINGS. USE ONLY DRAWINGS MARKED "ISSUED FOR CONSTRUCTION". VERIFY CONFIGURATIONS & DIMENSIONS ON SITE BEFORE BEGINNING WORK. NOTIFY ARCHITECT IMMEDIATELY OF ANY ERRORS, OMISSIONS OR DISCREPANCIES.

DEVELOPMENT CONSULTANT: API CONSULTANTS INC.

API 1464 CORNWALL ROAD, UNIT 7 OAKVILLE, ONTARIO L6J 7W5 P: 905.337.7249 CONSULTANTSING

ARCHITECT:

SAPLYS ARCHITECTS INC. 1464 CORNWALL ROAD, UNIT 8 OAKVILLE, ONTARIO L6J 7W5

STARNIGHT IMPORT & EXPORT 35B IRONSIDE CRESCENT SCARBOROUGH, ON M1X 1G5

NIGHT IMPORT & EXPORT



WAREHOUSE & OFFICE **HEADQUARTERS**

> **45 BLOWERS CRES** AJAX, ON L1Z 0N4

DRAWING TITLE DOOR SCHEDULE & TYP DETAILS

CHECK ISSUED FOR AGR NZ CLIENT REVIEW PROJECT NO.: | SHEET NO.: A22-018

SCALE:

As indicated


ISSUE DATE: 24-07-10


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WOOD

FRAME TYPES

PAINTED



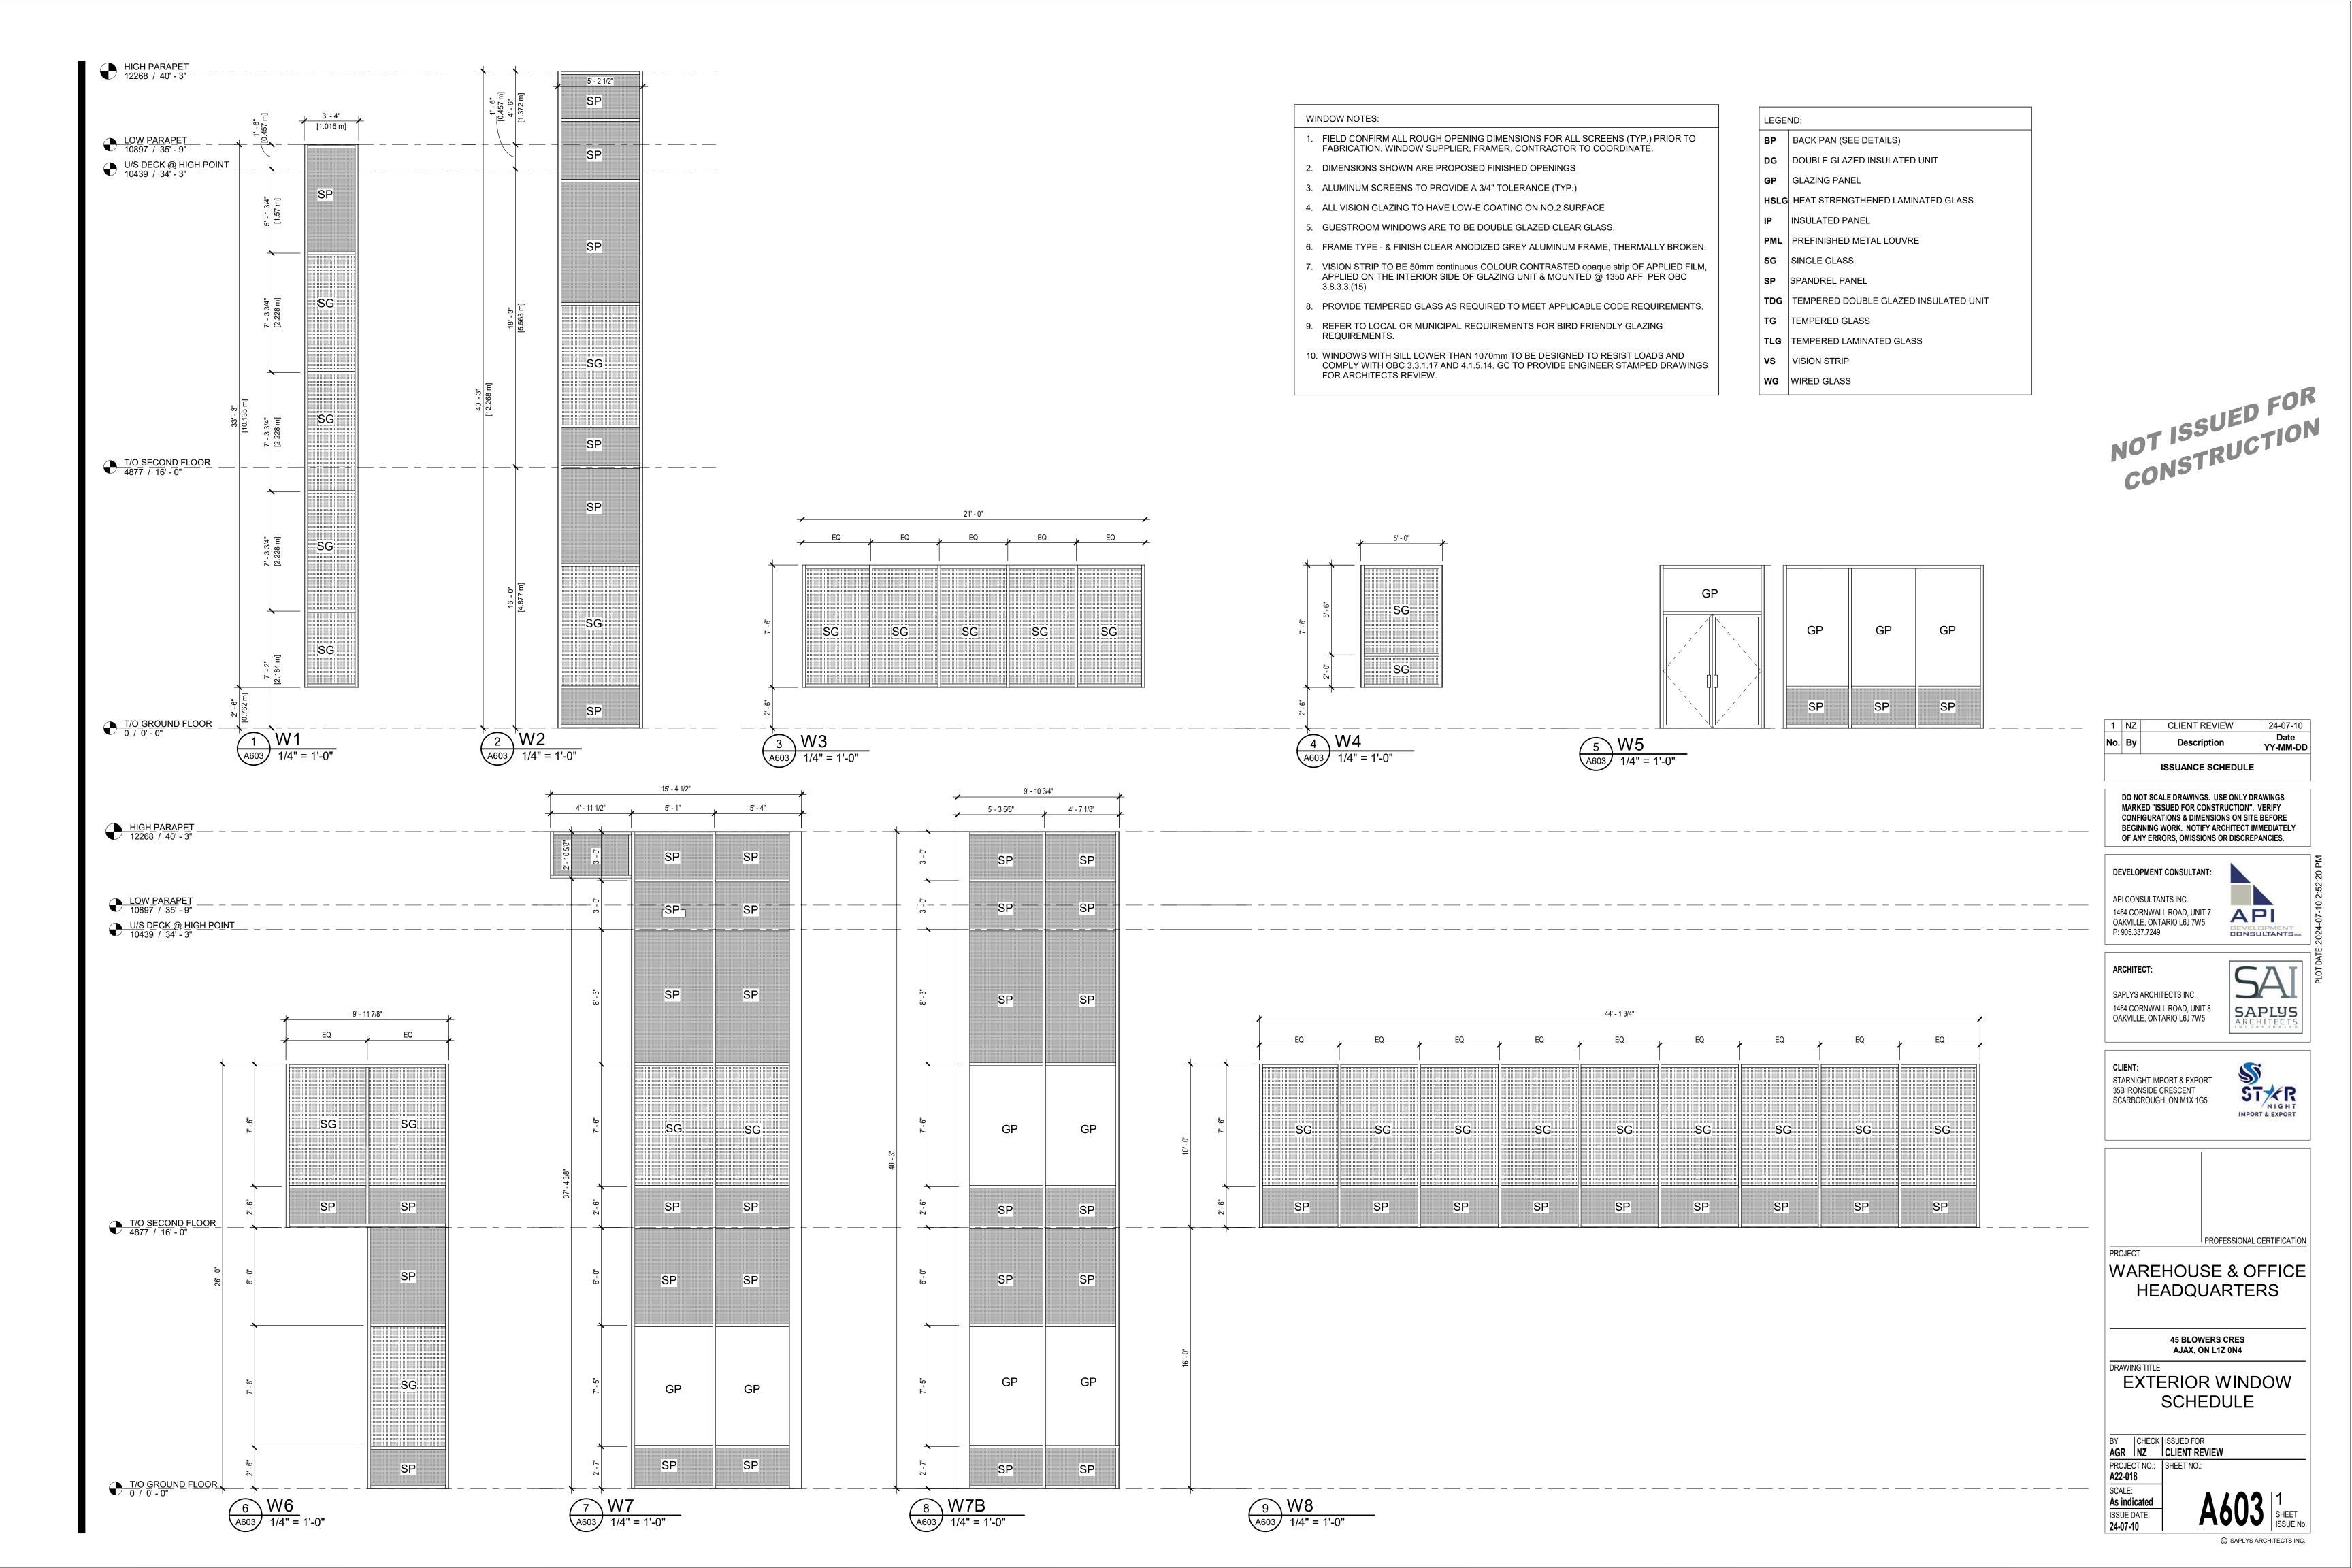

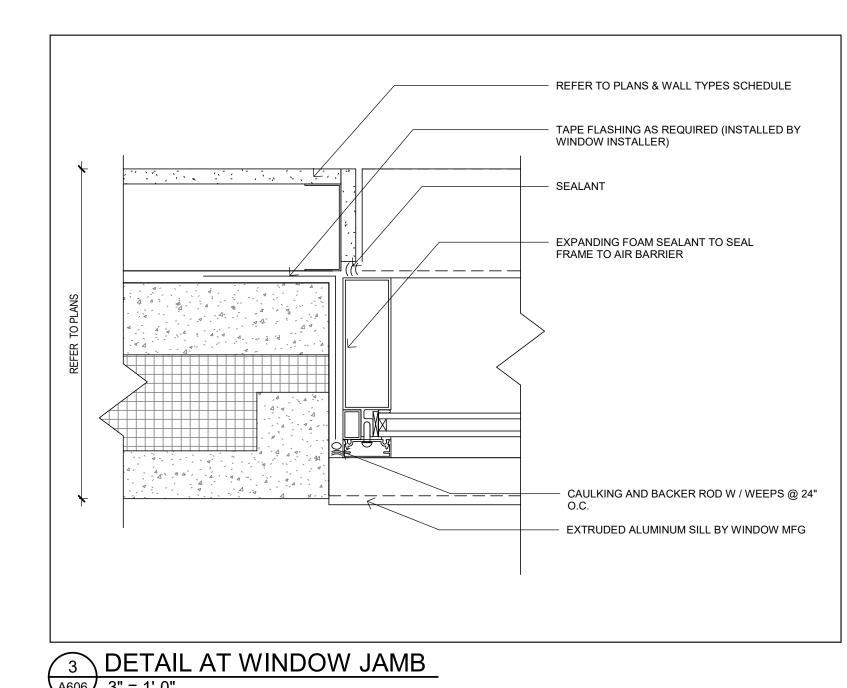
CLIENT REVIEW

ISSUANCE SCHEDULE


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24-07-10 Date YY-MM-DD

3 DETAIL AT WINDOW JAMB
A606 3" = 1'-0"

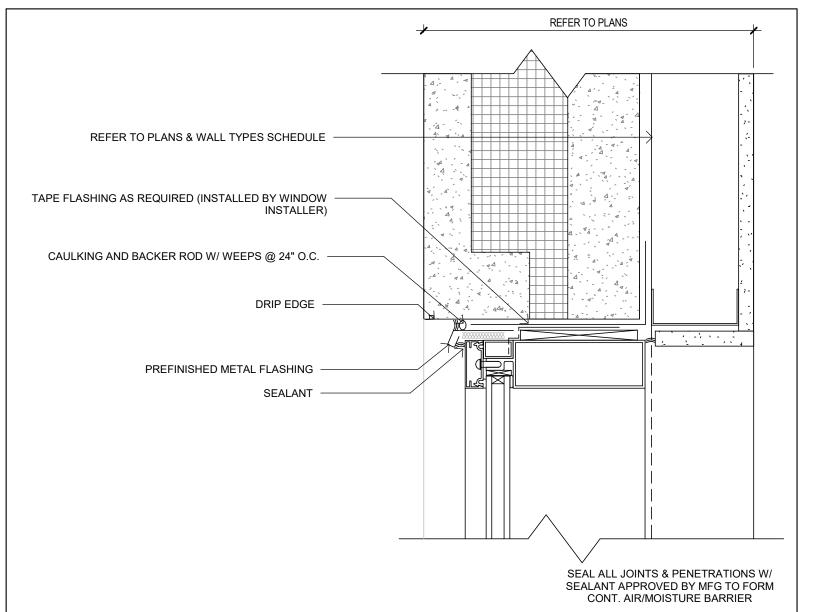

2 DETAIL AT WINDOW HEAD A606 3" = 1'-0"



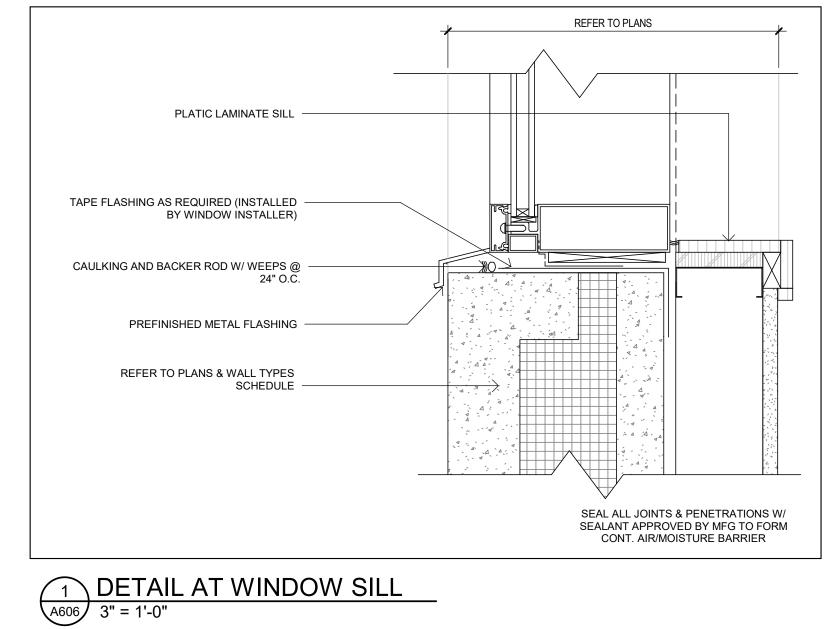



BY CHECK ISSUED FOR AGR NZ CLIENT REVIEW

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PROJECT NO.: | SHEET NO.: | A22-018 | SCALE: | 3" = 1'-0" | ISSUE DATE: | 24-07-10 |

1 NZ



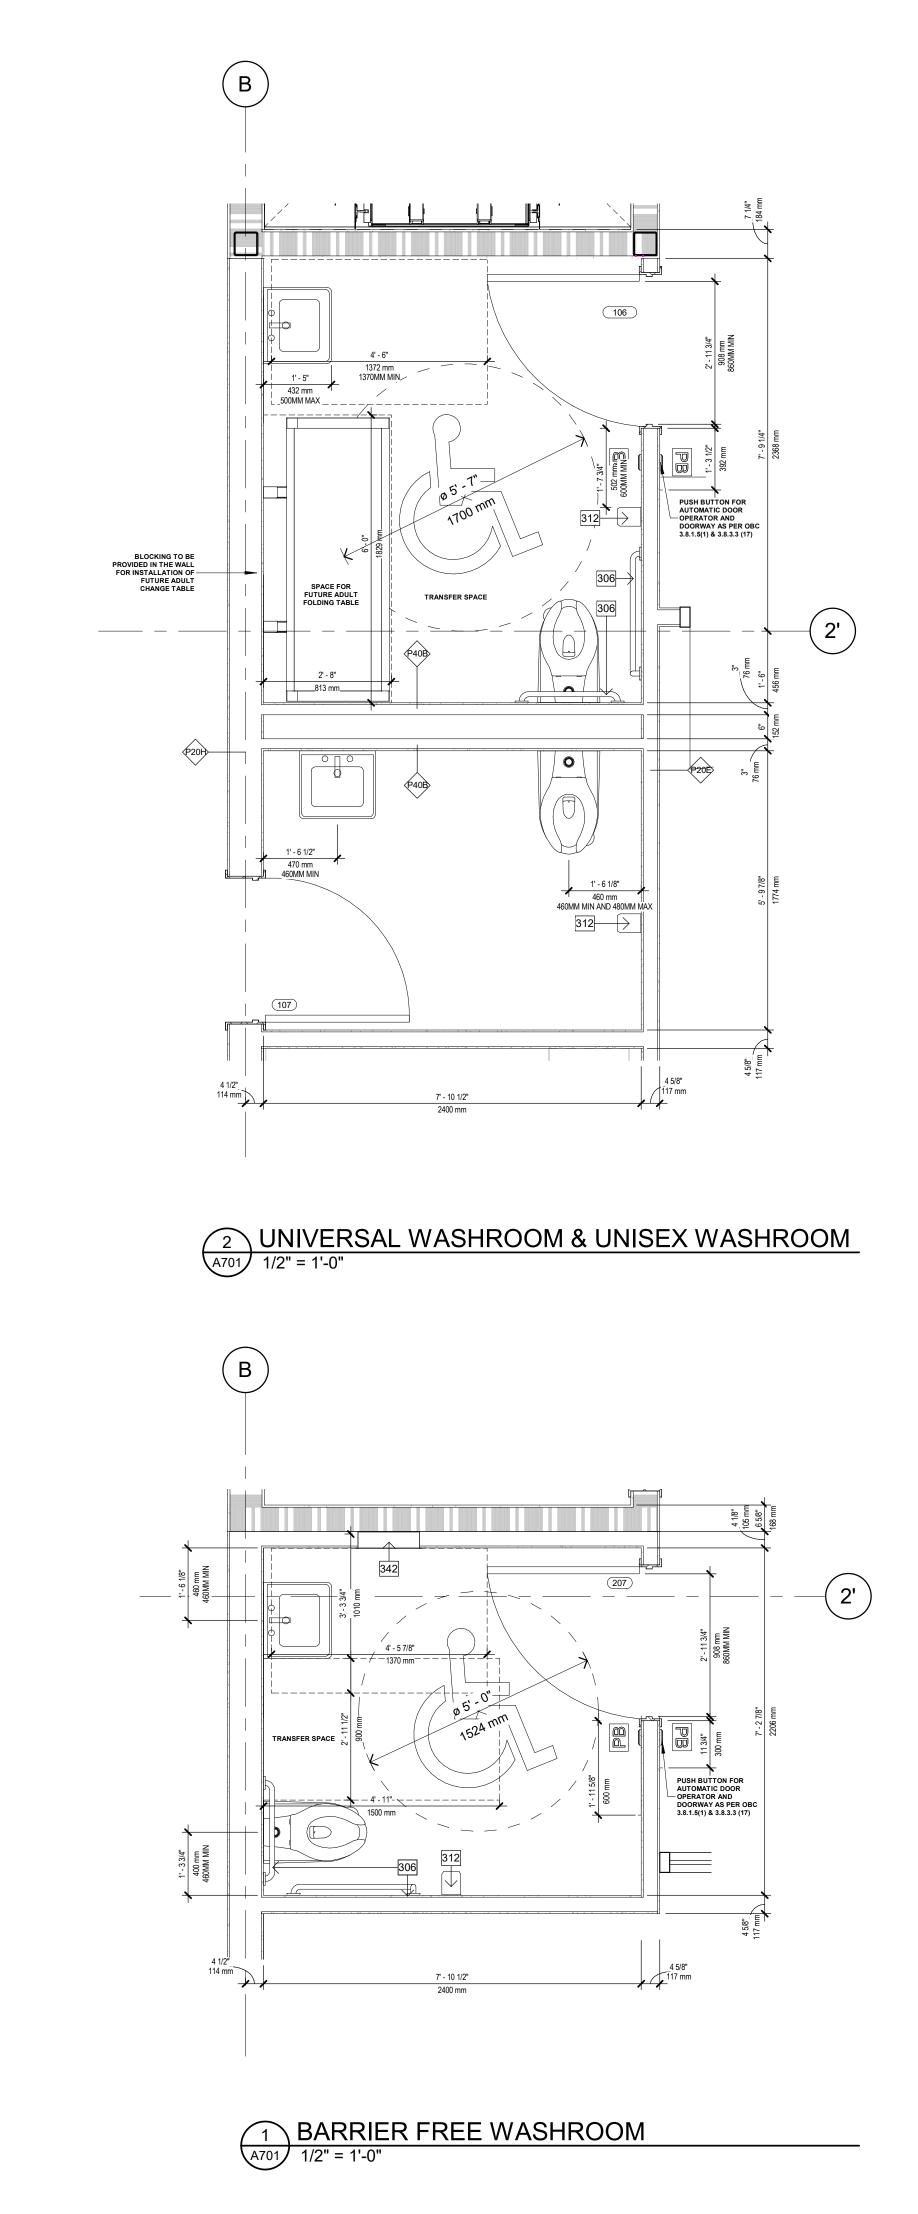

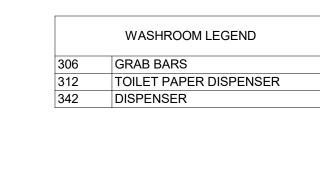Date YY-MM-DD ISSUANCE SCHEDULE

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DEVELOPMENT CONSULTANT: API CONSULTANTS INC.


1464 CORNWALL ROAD, UNIT 7 OAKVILLE, ONTARIO L6J 7W5 P: 905.337.7249 API CONSULTANTSING

ARCHITECT: SAPLYS ARCHITECTS INC.

1464 CORNWALL ROAD, UNIT 8 OAKVILLE, ONTARIO L6J 7W5

CLIENT: STARNIGHT IMPORT & EXPORT 35B IRONSIDE CRESCENT SCARBOROUGH, ON M1X 1G5



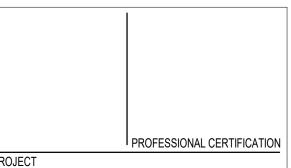


WAREHOUSE & OFFICE HEADQUARTERS

45 BLOWERS CRES AJAX, ON L1Z 0N4


WASHROOM PLANS

BY | CHECK | ISSUED FOR AGR | NZ PROJECT NO.: SHEET NO.: A22-018 SCALE:

1/2" = 1'-0" ISSUE DATE:

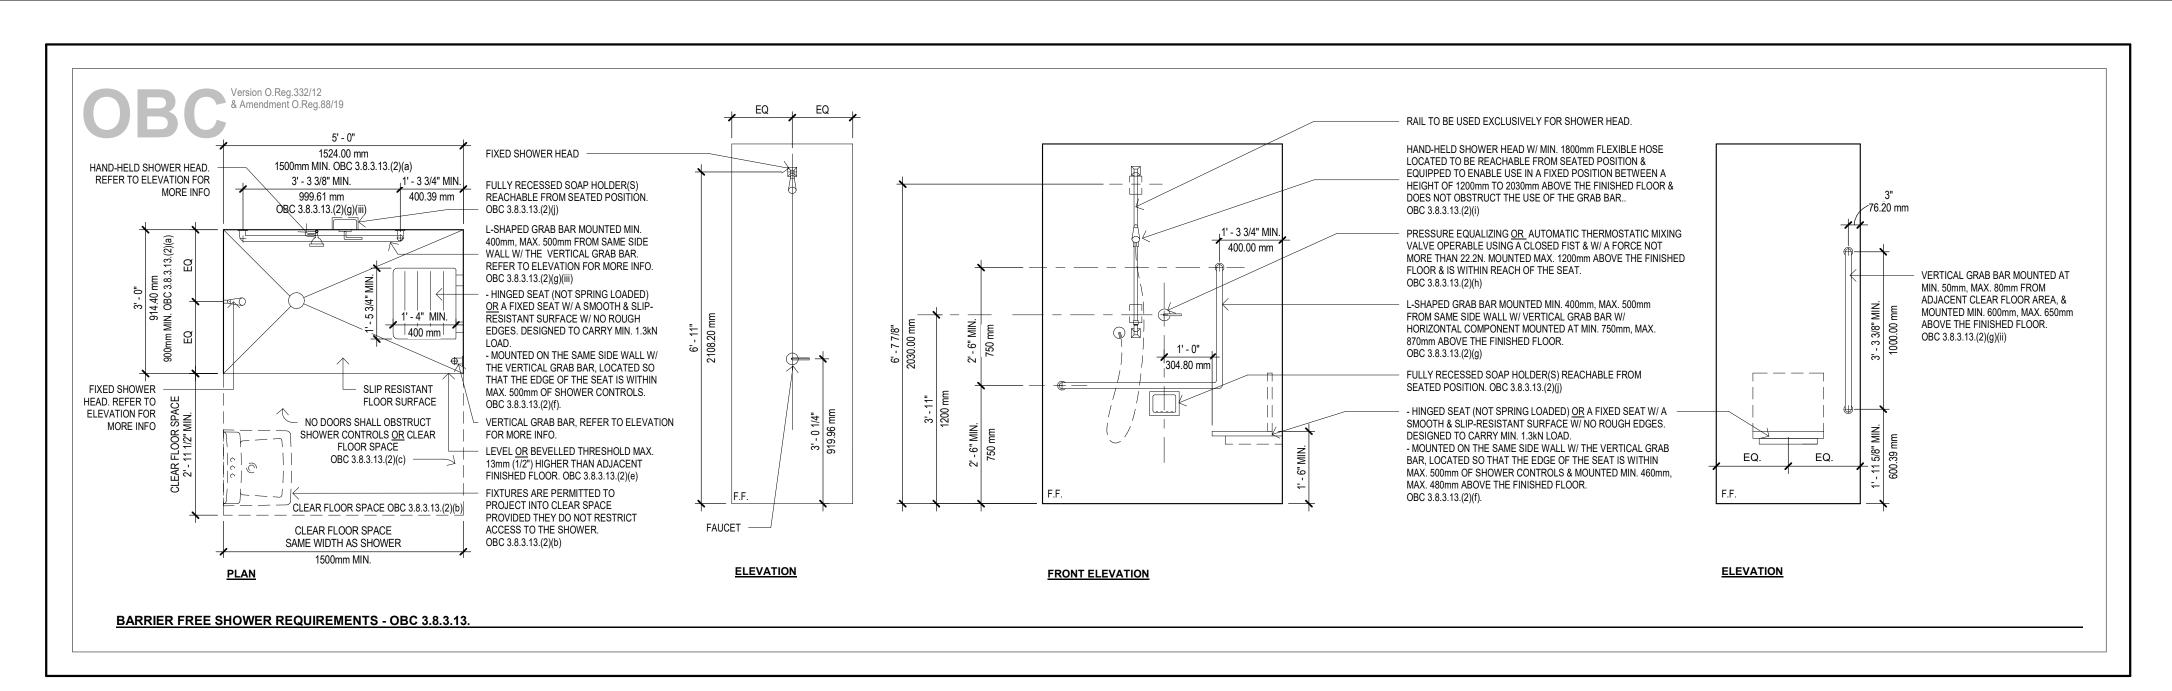

OBC BARRIER FREE BATHTUB & SHOWER REQUIREMENTS A800 1/2" = 1'-0"

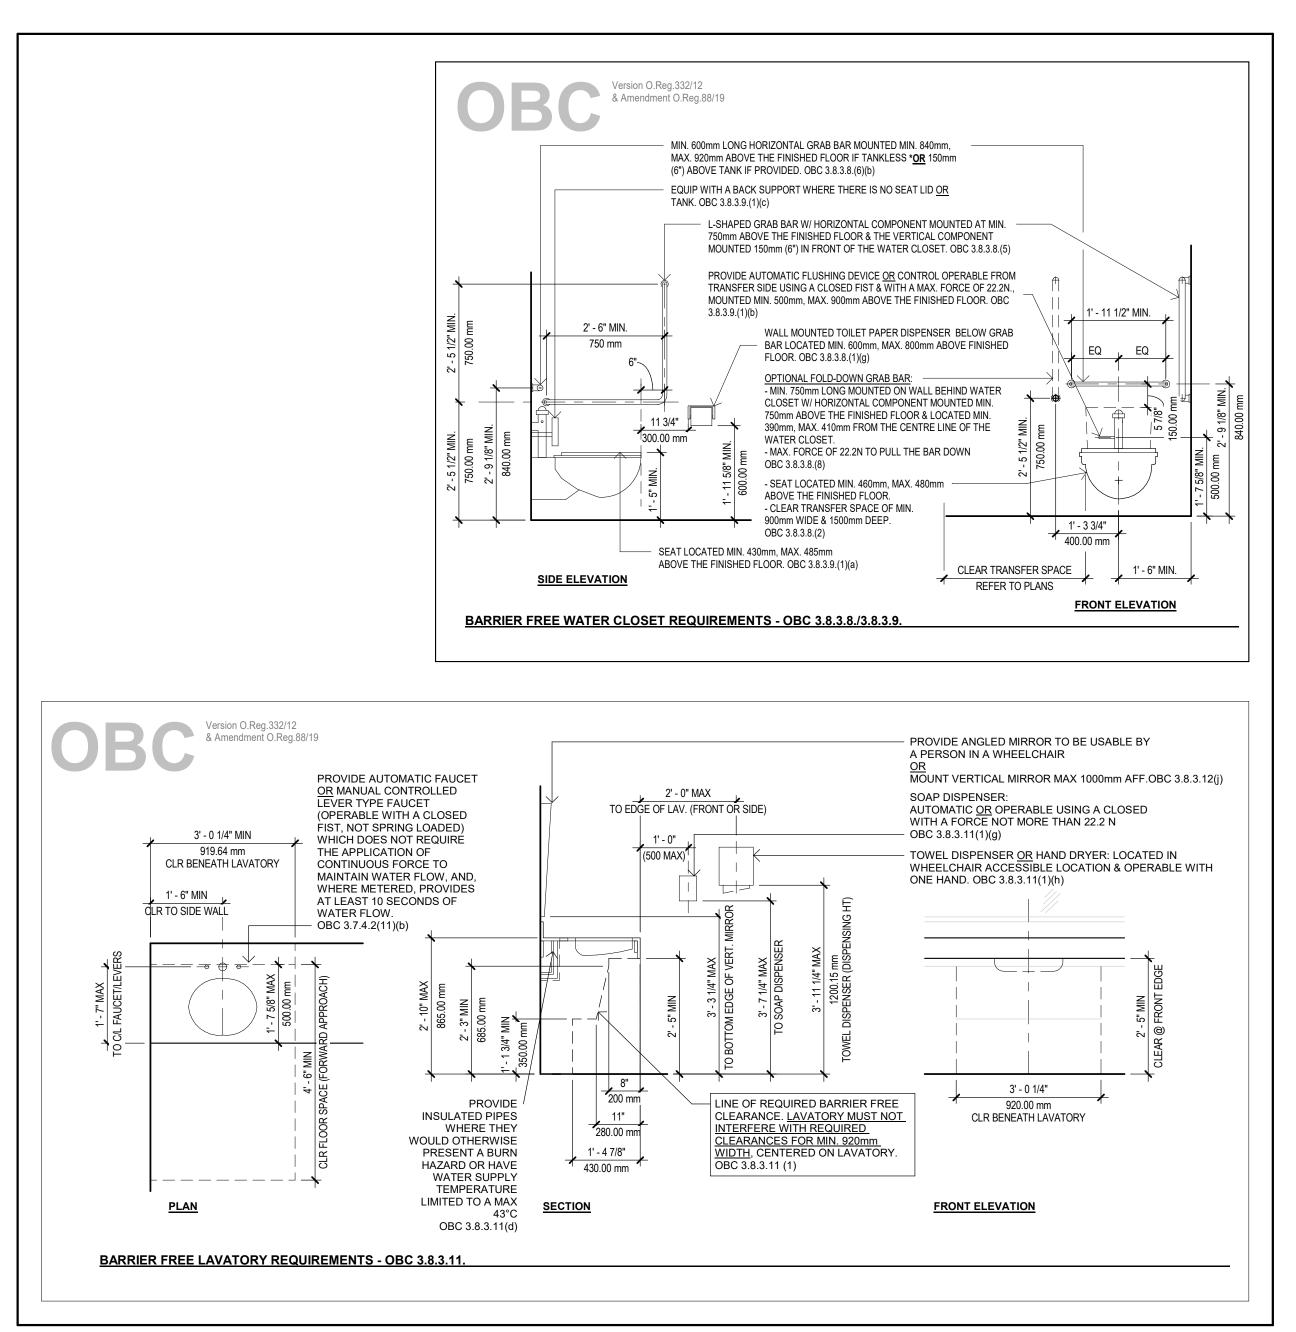


OBC BARRIER FREE WATER CLOSET, URINAL & LAVATORY REQUIREMENTS

A800) 1/2" = 1'-0"

OBC 3.8.3.11(1)(h) 600 mm S-----BARRIER FREE SINK 450.06 mm 2' - 6" 750 mm OBC 3.8.3.8(5)(a) BELOW GRAB BAR FINISH FLOOR GRAB BAR TOWEL BAR COAT HOOK BARRIER-FREE PAPER TOWEL SHOWER SEAT **ADJUSTABLE** ABOVE TOILET BESIDE OBC 3.8.3.8(1)(e) VERTICAL DISPENSER DISPENSER OBC 3.8.3.13.(2)(f) ADULT SIZE OBC 3.8.3.8.(6)(b) TOILET 3.8.3.11.(3) OBC 3.8.3.11.(1)(g) CHANGE TABLE DISPENSER OBC 3.8.3.8 (1)(g)(iv OBC 3.8.3.11.(1)(h) PROVIDE **ANGLED** MIRROR OBC 3.8.3.11.(2)

OBC TYP. BARRIER FREE MOUNTING HEIGHTS

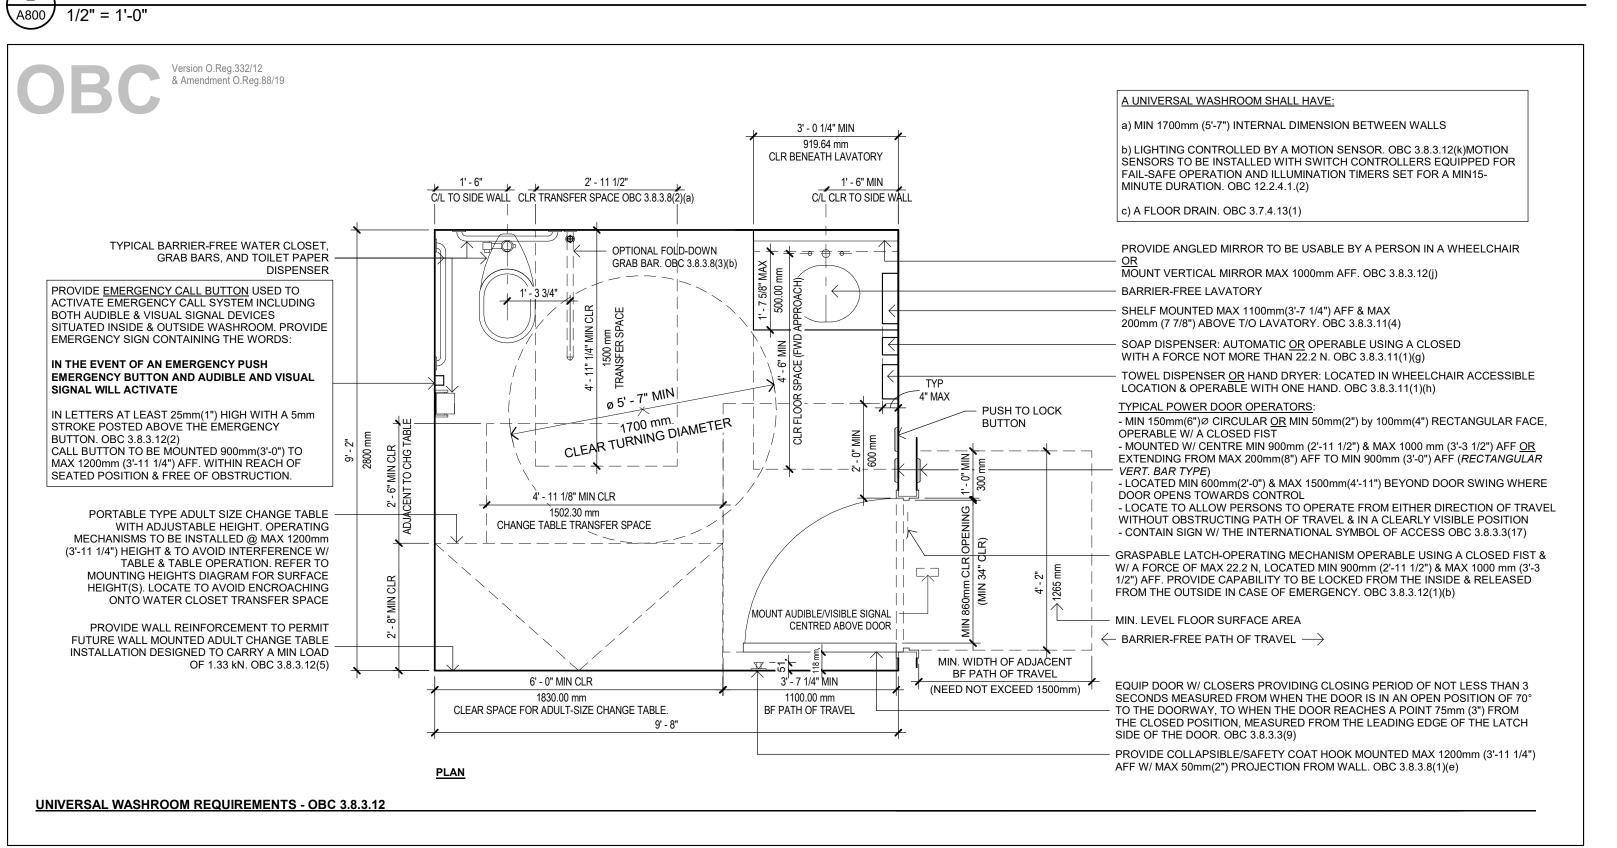

OBC UNIVERSAL WASHROOM REQUIREMENTS

NOT ISSUED FOR CONSTRUCTION

Description YY-MM-DD ISSUANCE SCHEDULE DO NOT SCALE DRAWINGS. USE ONLY DRAWINGS MARKED "ISSUED FOR CONSTRUCTION". VERIFY CONFIGURATIONS & DIMENSIONS ON SITE BEFORE **BEGINNING WORK. NOTIFY ARCHITECT IMMEDIATELY** OF ANY ERRORS, OMISSIONS OR DISCREPANCIES. DEVELOPMENT CONSULTANT: API CONSULTANTS INC. 1464 CORNWALL ROAD, UNIT 7 API OAKVILLE, ONTARIO L6J 7W5 P: 905.337.7249 CONSULTANTS ARCHITECT: SAPLYS ARCHITECTS INC. 1464 CORNWALL ROAD, UNIT 8 OAKVILLE, ONTARIO L6J 7W5 CLIENT: STARNIGHT IMPORT & EXPORT 35B IRONSIDE CRESCENT SCARBOROUGH, ON M1X 1G5 NIGHT IMPORT & EXPORT PROFESSIONAL CERTIFICATION **WAREHOUSE & OFFICE HEADQUARTERS** 45 BLOWERS CRES AJAX, ON L1Z 0N4 OBC UNIVERSAL WR AND BF **REQUIREMENTS** BY | CHECK | ISSUED FOR AGR NZ PROJECT NO.: | SHEET NO.:

A22-018

ISSUE DATE:

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SCALE: 1/2" = 1'-0"